

PUBLIC NOTICE CITY OF BEXLEY ARCHITECTURAL REVIEW BOARD BOARD OF ZONING AND PLANNING

The Bexley Architectural Review Board (ARB) will hold a Public Meeting on the following case on <u>Thursday, March 12, 2020 at 6:00 PM</u>, in City Council Chambers, Bexley City Hall, 2242 East Main Street, Bexley, Ohio.

The Bexley Board of Zoning and Planning (BZAP) will hold a Public Hearing on the following case on <u>Thursday, March 26, 2020 at 6:00 PM.</u>, in City Council Chambers, Bexley City Hall, 2242 East main Street, Bexley, Ohio.

The APPLICANT or REPRESENTATIVE must be present at the Public Hearing. The Board may dismiss, without hearing, an application if the applicant or authorized representative is not in attendance. The Board may move to consider the application in those circumstances where dismissal without hearing would constitute a hardship on the adjoining property owners or other interested persons.

a. Application No.: BZAP-20-3Applicant: Brenda Parker

Owner: 2700 Sherwood Rd. LLC Location: 2700 Sherwood Rd.

ARB Request: The applicant is seeking architectural review and a recommendation to the Board of Zoning and Planning, to allow a 676 square foot, detached garage that is 22'9" in height, to be constructed in the rear yard.

BZAP: The applicant is seeking architectural review and approval to allow a new detached garage. The applicant is also seeking a Special Permit f in accordance with Bexley Code Section 1252.15(e) which states an accessory structure shall not exceed one story in height, ridgeline not to exceed 20' in height without approval from the Board of Zoning and Planning, to allow the proposed detached garage, with 2nd floor space, to be 22'9" in height.

A copy of this application is available for review in the Building Department office during the hours of 8:00 A.M. until 4:00 P.M. If you have any questions, please call the Bexley Building Department at 559-4240.

Mailed by: 02-27-2020

*(BZAP)Board of Zoning & Planning Application - Review of Variance requests for Residential and Commercial Development

BZAP-20-3

Status: Active

Submitted: Feb 10, 2020

Applicant

<u>以</u> Brenda Parker

614-586-5514

@ brenda.parker@cbusarch.com

Location

2700 SHERWOOD RD Bexley, OH 43209

A.1: Project Information

Brief Project Description - ALSO PROVIDE 2 HARD COPIES (INCLUDING PLANS) TO THE BUILDING DEPARTMENT.

New 2-car detached garage with second floor storage space.

Architecture Review Conditional Use

true --

Demolition Planned Unit Dev

--

Rezoning Variance or Special Permit

- true

What requires Major Architectural Review

What requires Minor Architectural Review

New construction detached garage.

Major Architectural Review Minor Architectural Review

false true

A.1: Attorney / Agent Information

Agent Name Agent Address

Brenda Parker 930 Northwest Blvd

Agent EmailAgent Phonebrenda.parker@cbusarch.com614-586-5514

A.2: Fee Worksheet

Estimated Valuation of Project Minor Architectural Review

50000 true

Major Architectural Review Variance Review

true

Variance Review Type Zoning

Single Family --

Zoning Review Type Sign Review and Architectural Review for Commercial Projects

exceeding height limit

Review Type Appeal of ARB decision to BZAP

-

Appeal of BZAP decision to City Council

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Conditional Use - Explain type of Use if being requested and fill out Conditional Use Criteria

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B: Project Worksheet: Property Information

Occupancy Type Zoning District

Residential R-6

Use Classification

R-6 (35% Building and 60% Overall)

B: Project Worksheet: Lot Info

Width (ft) Depth (ft)

97.5

Total Area (SF)

14093

B: Project Worksheet: Primary Structure Info

Existing Footprint (SF) Proposed Addition (SF)

1977

Removing (SF)

Type of Structure

0 N/A

Proposed New Primary Structure or Residence (SF)

Total Square Footage

•

B: Project Worksheet: Garage and/or Accessory Structure Info (Incl. Decks, Pergolas, Etc)

Existing Footprint (SF) Proposed Addition (SF)

-

New Structure Type Ridge Height

Detached Garage 22'-9"

Proposed New Structure (SF) Is there a 2nd Floor

676 Yes

2nd Floor SF

406

Total of all garage and accessory structures (SF)

Total building lot coverage (% of lot)

Proposed Additional Hardscape (SF)

Total overall lot coverage (% of lot)

676

Total building lot coverage (SF)

2653

Existing Patio (SF)

Is this replacing an existing garage and/or accessory structure?

No

B: Project Worksheet: Hardscape

Existing Driveway (SF)

1903 246

Existing Private Sidewalk (SF)

226 155

Total Hardscape (SF)

2530

B: Project Worksheet: Total Coverage

Total overall lot coverage (SF)

5183 37

C.1 Architectural Review Worksheet: Roofing

Roofing

true

Existing Roof Type

New Single Manufacturer

GAF

Structure

Garage Only

New Roof Type

Arch. Dimensional Shingles

New Roof Style and Color

Slateline English Gray

C.1 Architectural Review Worksheet: Windows

Windows

true

Existing Window Type

Other existing window materials

Vinyl

New Window Style/Mat./Color Double Hung/Vinyl/Almond

Structure

Garage Only

Existing Window Materials

Other

New Window Manufacturer

Jeldwen

C.1 Architectural Review Worksheet: Doors

DoorsStructuretrueGarage Only

Existing Entrance Door Type Existing Garage Door Type

Door FinishProposed Door TypePaintedSteel insulated

Proposed Door Style Proposed Door Color

Carriage Style Sandtone

C.1 Architectural Review Worksheet: Exterior Trim

Exterior Trim Existing Door Trim

true --

Proposed New Door Trim Existing Window Trim

Smart Trim 3-1/2"

Proposed New Window Trim Trim Color(s)
Smart Trim 3-1/2"
Almond

Do the proposed changes affect the overhangs?

No

C.2 Architectural Review Worksheet: Exterior Wall Finishes

Exterior Wall Finishes Existing Finishes

true --

Existing Finishes Manufacturer, Style, Color Proposed Finishes

-- Other

Other Proposed Finishes Proposed Finishes Manufacturer, Style, Color

Stone veneer, stucco, cement board siding Dutch Quality Limestone, natural stucco, HardiLap &

HardiShingle siding

D: Tree & Public Gardens Commission Worksheet

Type of Landscape Project Landscape Architect/Designer

--

Architect/Designer Phone Architect/Designer E-mail

<u>.</u>

Project Description

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I have read and understand the above criteria

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D: (Staff Only) Tree & Public Gardens Commission Worksheet

Design plan with elevations (electronic copy as specified in instructions plus 1 hard copy)

Design Specifications as required in item 3 in "Review Guidelines and List of Criteria" above

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Applicant has been advised that Landscape Designer/Architect must be present at meeting

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E.1 Variance Worksheet

Description of the Proposed Variance. Please provide a thorough description of the variance being sought and the reason why.

Request variance from Section 1252.15 (e) to increase the height of a new detached garage from 20'-0" to 22'-9". The height is driven by the overall width of the garage. The vehicles to be parked in the garage require 10' wide garage doors. The code requires 2'-0" between garage doors for structural bracing. These dimensions result in the 26' garage width. The style of the garage works best with a steep pitch and is shown at 11/12. The 11/12 pitch at 26'-0" width forces the height above the 20'-0" limitation. Many pitches of roof were studied that worked within the 20'-0" height limit, but the 11/12 was the most aesthetically pleasing.

1. Does the property in question require a variance in order to yield a reasonable return? Can there be any beneficial use of the property without the variance? Please describe.

The height variance will allow for a detached garage that is aesthetically compatible with the existing house.

2. Is the variance substantial? Please describe.

The variance is not substantial; the request is to increase the height 2'-9" at the ridge above the 20'-0" limit.

3. Would the essential character of the neighborhood be substantially altered or would adjoining properties suffer a substantial detriment as a result of the variance? Please describe.

The essential character of the neighborhood would not be substantially altered with the variance. The composition of the garage creates interest and the garage looks best with the 11/12 roof pitch. Adjoining properties will not suffer substantial detriment as a result of the variance. The roof slope in the east/west direction allows for light to filter into the west neighbor's property. The additional height at the ridge will not greatly affect the shading to the neighbor to the north.

E.2 Variance Worksheet

4. Would the variance adversely affect the delivery of governmental services (e.g. water, sewer, garbage)? Please describe.

The variance will have no impact on the delivery of governmental services.

5. Did the property owner purchase the property with the knowledge of zoning restriction? Please describe.

The property owner did not have an in-depth knowledge of the Bexley zoning code and the detached garage height limitation when purchasing the property.

6. Can the property owner's predicament feasibly obviated through some method other than a variance? Please describe.

The pitch of the garage roof could be adjusted to work within the 20' height limit but the garage aesthetic would be sacrificed.

7. Is the spirit and intent behind the zoning requirement observed and is substantial justice done by granting the variance? Please describe.

The spirit and intent behind the zoning requirement is observed and substantial justice is done.	The height increase is minimal with
aesthetics driving the variance request.	

F.1 Fence Variance Worksheet

Lot Type

Narrative description of how you plan to meet the pertinent outlined variance criteria

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F.1-F.2 Fence Variance Worksheet: Side and Rear Yard Restrictions for Corner Lots

- 1. Compatibility: Describe how the proposed side yard fence or wall exceeding forty-eight inches in height and on the street side of a corner lot compatible with other properties in the neighborhood?
- 2. Height: Please verify that the maximum height of such fence or wall shall not exceed seventy-two inches as measured from the average grade, as defined in Section 1230.06. Artificially raising the height of the lot line by the use of mounding, retaining walls or similar means shall be included within the seventy-two inch maximum height.
- 3. Transparency: Fences exceeding forty-eight inches in height should include transparency in the upper 12" to 18" of the fence through the use of latticework, pickets, or other appropriate design elements. Describe how you have satisfied this requirement.
- 4. Screening: A landscaping plan must be filed with the application for a special permit, indicating how such fencing or wall is to be screened from the street side elevation. The landscape plan should be designed in such a way as to mitigate the impact of a solid fence or wall as it relates to the street and other properties. Describe how the landscape plan addresses these items.
- 5. Visibility and Safety: The installation of such fence or wall shall not create a visibility or safety concern for vehicular and/or pedestrian movement. Please describe any visibility/safety concerns with your design.
- 6. Material Compatibility: No chain link, wire mesh or other similar material shall be installed on lot lines adjacent to public rights-of-way. Please verify that your design complies with this requirement.
- 7. Finished Side: Any fence or wall erected on a lot located at the intersection of two or more streets must have the finished and not the structural side facing the adjacent property, alley or street. Please verify that your design complies with this requirement.

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F.3 Fence Variance Worksheet

Front Yard Restrictions Fences Adjacent to Commercial Districts

Require Commercial Fences Adjacent to Residential Districts

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movement.

F.3 Fence Variance Worksheet: Front Yard Restrictions

The proposed decorative landscape wall or fence is compatible with other properties in the neighborhood.

The height of the fence or wall does not exceed the size permitted as above when measured from the average grade of the yard where the fence or wall is to be installed. Artificially raising the height of the lot line by the use of mounding, retaining walls or similar means shall be included in the maximum height.

Posts, columns and finials may extend up to 6" above the maximum allowed height of the fence panels. CHAPTER 1264. **FENCES AND WALLS City of Bexley Zoning Ordinance**

A landscaping plan shall be filed with the application indicating how such fencing and/ or wall is to be integrated with existing front yard landscaping.

The installation of such fence and/or wall shall not create a visibility or safety concern for vehicular and/or pedestrian

No chain link, wire mesh, concrete block or other similar type material shall be installed as a decorative landscape wall or

fence.

The fence and/or wall shall have a minimum of 50% transparency.

That the lot exhibits unique characteristics that support the increase in fence height.

G. Demolition Worksheet

Is your property historically significant? Please attached supporting documentation. Recomended sources include ownership records, a letter from the Bexley Historical Society, etc.

Is your property architecturally significant? Please attached supporting documentation. Recomended sources include a letter of opinion from an architect or expert with historical preservation expertise.

If you answered "yes" to either of the above two questions, please describe any economic hardship that results from being unable to demolish the primary residence, and attach any supporting evidence.


If you answered "yes" to either of the above two questions, please describe any other unusual or compelling circumstances that require the demolition of the primary residence, and attach any supporting evidence.

I will provide a definite plan for reuse of the site, including proposed replacement structures, by completing Worksheets B & C and any other pertinent worksheets, along with required exhibits.

Provide a narrative time schedule for the replacement project

Please provide a narrative of what impact the proposed replacement project will have on the subject property and the neighborhood.

Attachments (9)

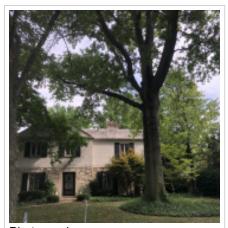

Photographs Feb 10, 2020



2700 Sherwood-2.jpg Feb 10, 2020

pdf Architectural Details

Feb 10, 2020

pdf Architectural Plan

Feb 10, 2020

pdf Exterior Elevations

Feb 10, 2020

pdf Floor Plan

Feb 10, 2020

pdf Site Plan

Feb 10, 2020

pdf A2.5.pdf

Feb 10, 2020

pdf 2020.0305 2700 Sherwood Exterior Elevation House-Garage.pdf

Mar 06, 2020

Timeline

Payment

Status: Paid February 11th 2020, 8:40 am

Zoning Officer

Status: Completed February 12th 2020, 7:45 am

Assignee: Kathy Rose

Kathy Rose February 12th 2020, 7:44:55 am

variance to height and size of accessory structure - March ARB & BZAP meetings

Brenda Parker March 4th 2020, 3:49:54 pm

Request variance from Section 1252.15 (e) to increase the height of a new detached garage from 20'-0" to 22'-9".

Kathy Rose March 4th 2020, 4:08:13 pm

I understand and have included that in the Notice sent to neighbors. I also think it would be most helpful to show the proposed garage and existing principal structure together in a scaled plan to allow Board Members to compare the size of the proposed garage with the existing principal structure.

Brenda Parker March 4th 2020, 4:20:16 pm

Floor plan or exterior elevation?

Kathy Rose March 4th 2020, 4:27:17 pm

e	elevation - Thanks!
E	Brenda Parker March 6th 2020, 1:32:20 pm
I	just uploaded the exterior elevation of the house with the garage in the background. The file is "2020.0305 2700 Sherwood Exterior
E	Elevation House-Garage".
	Design Planning Consultant
	Status: In Progress
	Assignee: Karen Bokor
	Architectural Review Board
	Status: In Progress
	Board of Zoning and Planning
	Status: In Progress
	City Council
	City Council
	Status: In Progress
	Tree Commission
	Status: In Progress
	Arborist
	Status: In Progress



WINDOW & DOOR SCHEDULE

2700 Sherwood Road

New Construction Windows to be Jeldwen V-4500 vinyl windows (with grilles). New Construction Door to be steel: paint in field.

Glass: LoE-272 with Argon. Exterior Color: Almond (verify). Interior Color: White.

	# NOMENCLATURE (OPERATION	NOTES
	(10)	Double (Frame Size 2'-0" x 4'-0")	Double hung	North/South
	02	Double (Frame Size 2'-0" x 3'-4")	Double hung	East/West
(11) Swing Door (2'-8" x 6'-8")				
		Swing Door	6-panel steel Tempered, labeled glass	

CODED NOTES

HardiLap siding, smooth, 5" exposure. Paint in field with (1)coat primer + (2)coats high-quality acrylic.

Trim to consist of:

Corner Trim: Smart Trim 3-1/2". Casings: Smart Trim 3-1/2". Frieze Board Trim: 3-1/2".

- 5" aluminum ogee gutter & 3" downspouts on 1x6 aluminum-wrapped wood fascia.
- Soffit to consist of Smart Trim soffit (vented at eaves; solid at gables).
- 4 Roofing: Asphalt shingle, GAF Slateline, color "English Gray".
- Concrete masonry unit foundation wall (buff-colored split face above grade) or cast-in-place concrete foundation wall.
- New overhead sectional garage door 10' wide x 8' height.
 Clopay Coachman Series 1, Design 11, Windows REC14,
 Frosted Glass, Color Sandtone (verify), No Hardware. Provide optional price for Clopay Canyon Ridge (same design as above) in Cypress Walnut Finish.
- HardiShingle siding, smooth, staggered edge. Paint in field with (1)coat primer + (2)coats high-quality acrylic.

Trim to consist of

Corner Trim: Smart Trim 3-1/2".

Casings: Smart Trim 3-1/2".

Frieze Board Trim: 3-1/2".

- 8 Custom overhang with standing seam metal roofing; paint all. Smart Trim soffit at ceiling.
- 3-Coat stucco system on water-resistant barrier on air barrier (Tyvek) with lathing per stucco manufacturer's installation recommendations.
- Cultured stone (Dutch Quality, Limestone, Ohio Tan); install per manufacturer's installation instructions.
- Standing seam metal roofing (dark bronze).

Architect: Brenda Parker 614-586-5514



NEW DETACHED GARAGE 2700 SHERWOOD ROAD BEXLEY, OHIO 43209

Permit Set

As Noted


SE ELEVATIONS

DATE:

Feb 10, 2020 SHEET NO.

A2.4



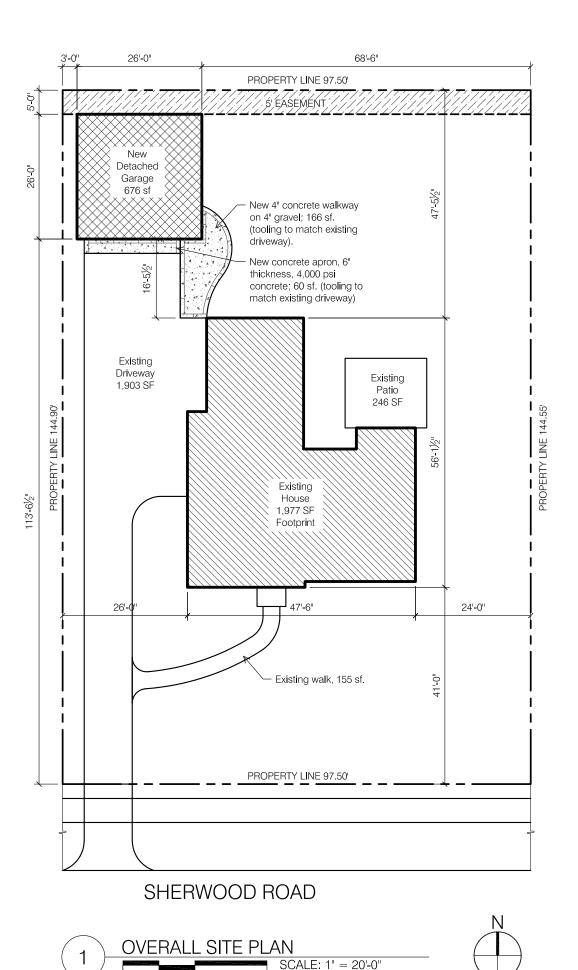

GENERAL INFORMATION

2700 Sherwood Road Address: Bexley, Ohio 43209 Parcel:

020-003119-00

Scope of Project: The project consists of the construction of a new 2-car detached garage with second floor storage space.

Footprint New Detached Garage: 676 sf Second Floor Storage Area: 406 sf

Zoning: Bexley R-6

Lot Area & Lot Width	Actual	Zoning Req't
Lot Area:	14,093 sf	6,000 sf
Lot Width:	97.50'	50'
Lot Depth	145.55'	120'
Building Lot Coverage		
Existing House	1,977 sf	4,932 sf (35%)
New Detached Garage	676 sf	1,002 01 (0070)
Total Building Coverage	2,653 sf (19%)	Meets Zoning
T . II . O		
Total Lot Coverage		
Total Building Coverage	2,653 sf	8,455 sf (60%)
Driveway	1,903 sf	
Front walk	155 sf	
Existing patio	246 sf	
New apron	60 sf	
New walkway	166 sf	
Total Lot Coverage	5,183 sf (37%)	Meets Zoning
Detached Garage	Actual	Zoning Pogt
Detached Garage		Zoning Req't
Garage SF:	676 sf	691 sf (35% of 1,977sf)
Garage Height	22'-8"	20'-0" (Request Variance
Garage Rear Setback:	5'-0"	3'-0"
Garage Side Setback:	3'-0"	3'-0"

SHEET INDEX

A1.0	Site Plan & General Info	A2.4	Garage Elevations
A2.1	Garage Plans	A2.5	Garage Overall Sections
A2.2	Foundation & Roof Plan		
A2.3	Garage Electric Plans		

DESIGN CRITERIA


Design Criteria: Wind Speed = 115 mph Seismic Category = A Weathering = Severe Frost Line Depth = 36" Termite = Moderate to Heavy Ice Barrier Underlayment = Yes, Required.

Floor Live Load = 40 psf Snow Load Roof = 20 psf

Foundation Concrete Compressive Strength = 2,500

Slab Concrete Compressive Strength = 3,000; air-entrained 5%-7%

Architect: Brenda Parker 614-586-5514

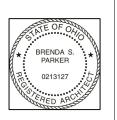

NEW DETACHED GARAGE 2700 SHERWOOD ROAD BEXLEY, OHIO 43209


Permit Set

SCALE: As Noted PROJECT NO.:

DATE: Feb 10, 2020

SHEET NO.

A1.0

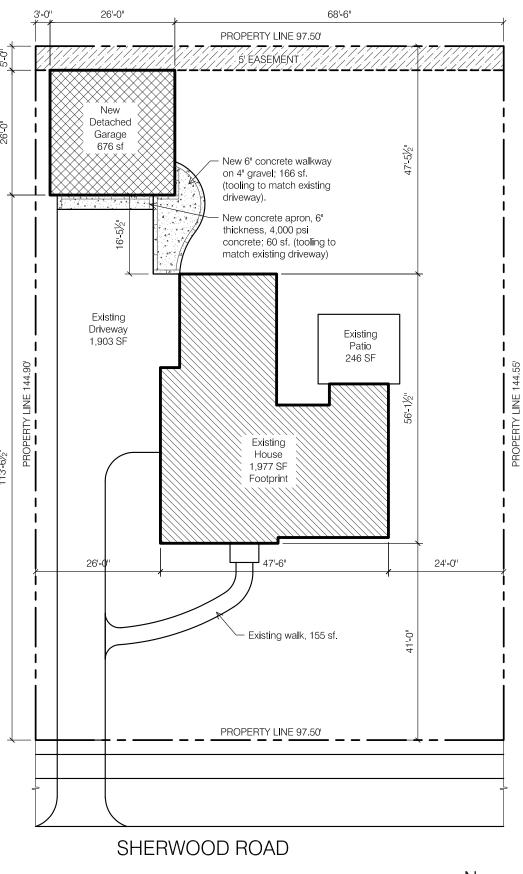





GENERAL INFORMATION

2700 Sherwood Road Address: Bexley, Ohio 43209 Parcel:

020-003119-00

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Total Building Coverage	2,653 sf	8,455 sf (60%)
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Detached Garage	Actual	Zoning Req't
Garage SF:	676 sf	691 sf (35% of 1,977sf)
Garage Height:	22'-9"	20'-0" (Request Variance)
Garage Rear Setback:	5'-0"	3'-0"

SHEET INDEX

A1.0	Site Plan & General Info	A2.4	Garage Elevations
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A2.3	Garage Electric Plans		

DESIGN CRITERIA

Design Criteria: Wind Speed = 115 mph Seismic Category = A Weathering = Severe Frost Line Depth = 36" Termite = Moderate to Heavy


Ice Barrier Underlayment = Yes, Required.

Floor Live Load = 40 psf Snow Load Roof = 20 psf

Foundation Concrete Compressive Strength = 2,500

Slab Concrete Compressive Strength = 3,000; air-entrained 5%-7%

Architect: Brenda Parker 614-586-5514

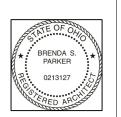

NEW DETACHED GARAGE 2700 SHERWOOD ROAD BEXLEY, OHIO 43209

Permit Set

SCALE: As Noted

PROJECT NO.:

DATE:

March 15, 2020 SHEET NO.

Architect: Brenda Parker 614-586-5514



NEW DETACHED GARAGE 2700 SHERWOOD ROAD BEXLEY, OHIO 43209

Permit Set

SCALE: As Noted


PROJECT NO.:

DATE:

March 15, 2020 SHEET NO.

A2.1

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NEW DETACHED GARAGE 2700 SHERWOOD ROAD BEXLEY, OHIO 43209

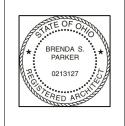

SHEET NO.
A2.2


A2.5 Install standing seam metal roofing at eave return; north & south. Asphalt Shingle Asphalt Shingle 11/12 pitch 11/12 pitch Install 2" R10 8" concrete block 4" Concrete slab wall (solid top Foamular 250 rigid on grade with 6x6 course) or 8" W2.9/W2.9 WWF insulation at cast-in-place interior face of on vapor barrier concrete foundation wall on 4" gravel fill. foundation wall on (full perimeter); 1'-4" wide x 8" see sections. Ridge vent 15 l.f. deep concrete footing with (2) #5 continuous Slope concrete slab 1/8" / ft. Bottom of footing 3'-0" below grade. Control Asphalt Shingle on Asphalt Shingle on joint, typ. double underlayment double underlayment 4/12 pitch 4/12 pitch Hardi or SmartTrim soffit 2 A2.5 panel with venting at east & west. 3-0 Hold down 5" aluminum Hold down foundation ogee gutter & 3" foundation Asphalt Shingle Asphalt Shingle wall at door. downspouts; wall at door. 11/12 pitch 11/12 pitch east & west. A2.5 2'-0" 2'-0" 10'-0" 10'-0" 2'-0"


GARAGE FOUNDATION PLAN


SCALE: 3/16" = 1'-0"

2 GARAGE ROOF PLAN

SCALE: 3/16" = 1'-0"

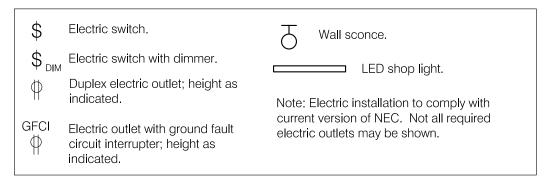

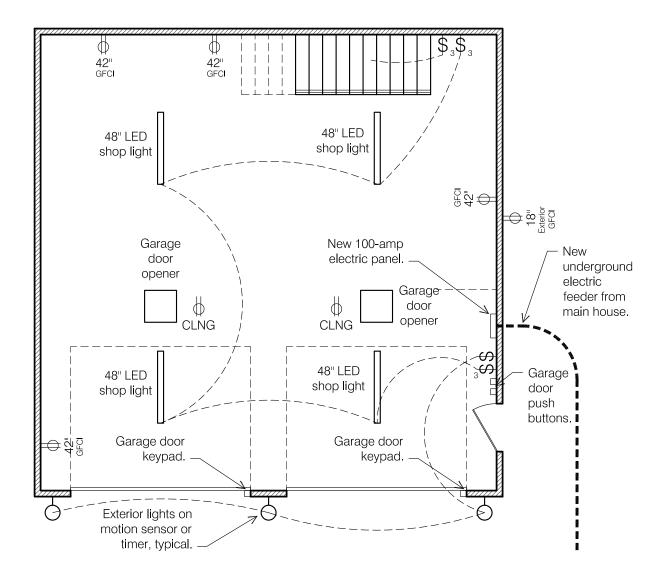

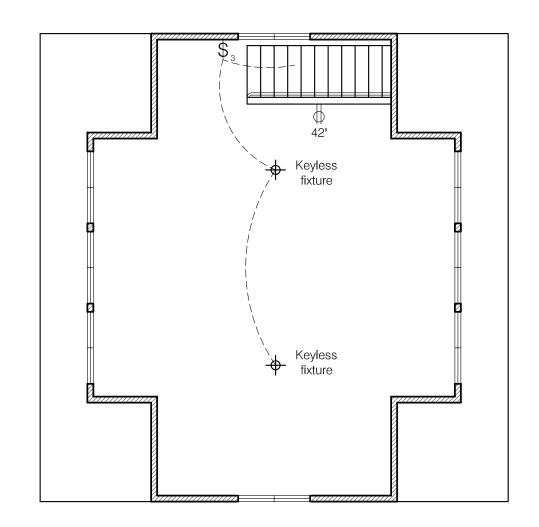

GARAGE ELECTRIC PLAN

SCALE: 3/16" = 1'-0"



Architect: Brenda Parker 614-586-5514



NEW DETACHED GARAGE 2700 SHERWOOD ROAD BEXLEY, OHIO 43209

Permit Set	
SCALE:	-
As Noted	
PROJECT NO.:	PLANS
	ELECTRIC
	Ē
	BARAGE
DATE:	AR
March 15, 2020	Q
SHEET NO	

A2.3





WINDOW & DOOR SCHEDULE

2700 Sherwood Road

New Construction Windows to be Jeldwen V-4500 vinyl windows (with grilles). New Construction Door to be steel; paint in field.

Glass: LoE-272 with Argon. Exterior Color: Desert Sand (verify).

Interior Color: White.

#	NOMENCLATURE	OPERATION	NOTES
01	Double (Frame Size 2'-0" x 4'-0")	Double hung	North/South
02)	Double (Frame Size 2'-0" x 3'-4")	Double hung	East/West
11)	Swing Door (2'-8" x 6'-8")	Swing Door	6-panel steel

CODED NOTES

HardiLap (or LP) siding, smooth, 8" exposure. Paint in field with (1)coat primer + (2)coats high-quality acrylic. Trim to consist of:

Corner Trim: Smart Trim 7-1/4". Casings: Smart Trim 3-1/2". Frieze Board Trim: 3-1/2".

- ALT Provide alternate price to install Boral siding, 8" exposure with mitered corners. Paint in field with (1) coat primer +(2) coats high-quality acrylic. All trim sizes noted above to be provided in Boral trim.
- 5" aluminum ogee gutter & 3" downspouts on 1x6 aluminum-wrapped cedar wood fascia.
- Soffit to consist of Smart Trim soffit (vented at eaves; solid at gables).
- Roofing: Asphalt shingle, GAF Slateline, color "English Gray".
- Concrete masonry unit foundation wall (buff-colored split face above grade) or cast-in-place concrete foundation wall.
- New overhead sectional garage door 10' wide x 8' height. Clopay Coachman Series 1, Design 11, Windows REC14, Frosted Glass, Color Sandtone (verify), No Hardware. Provide optional price for Clopay Canyon Ridge (same design as above) in Cypress Walnut Finish.
- Custom overhang with standing seam metal roofing; paint all. Smart Trim soffit at ceiling.
- Standing seam metal roofing (dark bronze).

Architect: Brenda Parker 614-586-5514



NEW DETACHED GARAGE 2700 SHERWOOD ROAD BEXLEY, OHIO 43209


Permit Set

SCALE:

As Noted PROJECT NO.:

ELEVATIONS DATE:

March 15, 2020 SHEET NO.

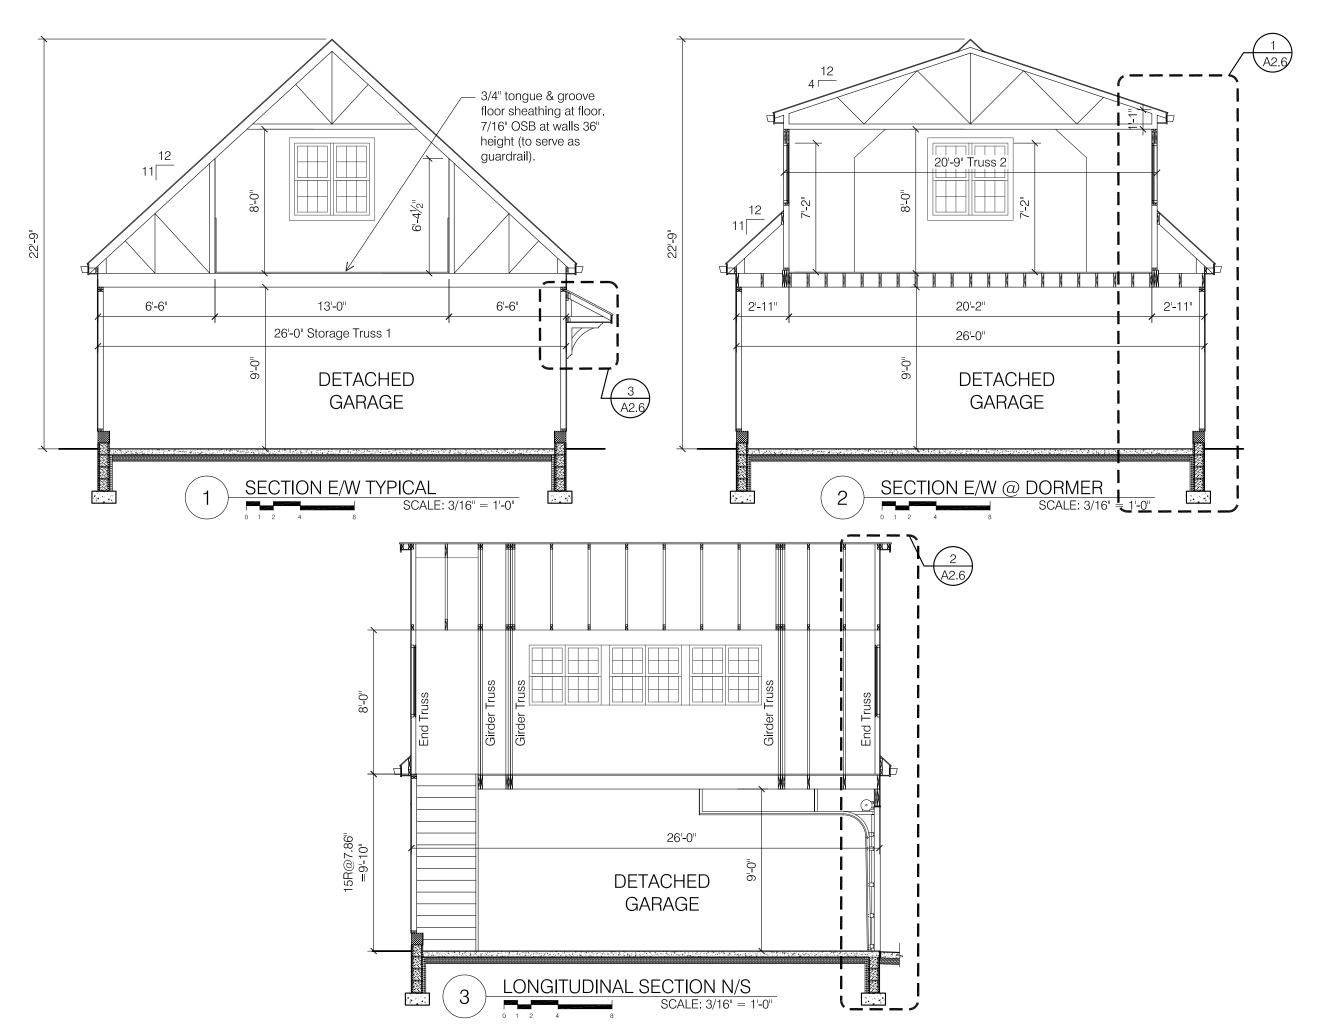


Architect:
Brenda Parker
614-586-5514





NEW DETACHED GARAGE 2700 SHERWOOD ROAD BEXLEY, OHIO 43209

Permit Set	
SCALE: As Noted	-
PROJECT NO.:	SECTIONS
	OVERALL
DATE	3ARAGE
DATE: March 15, 2020	GAF
SHEET NO.	

A2.5

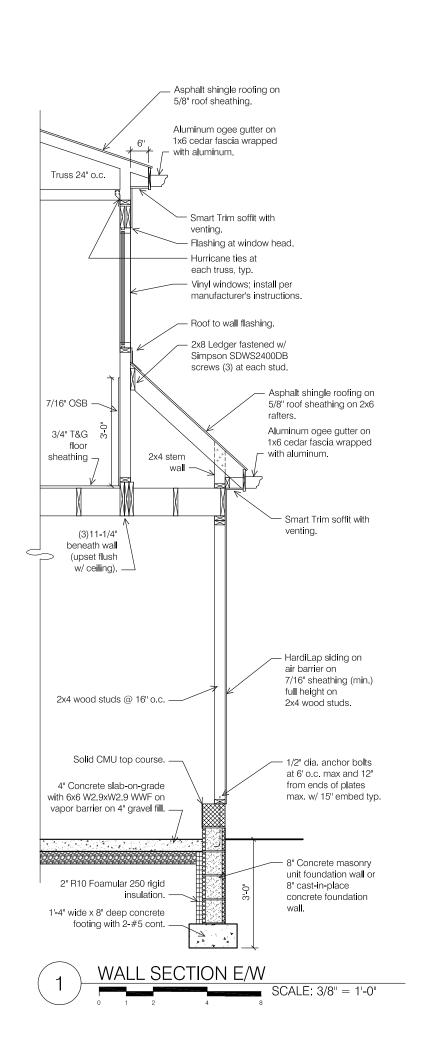

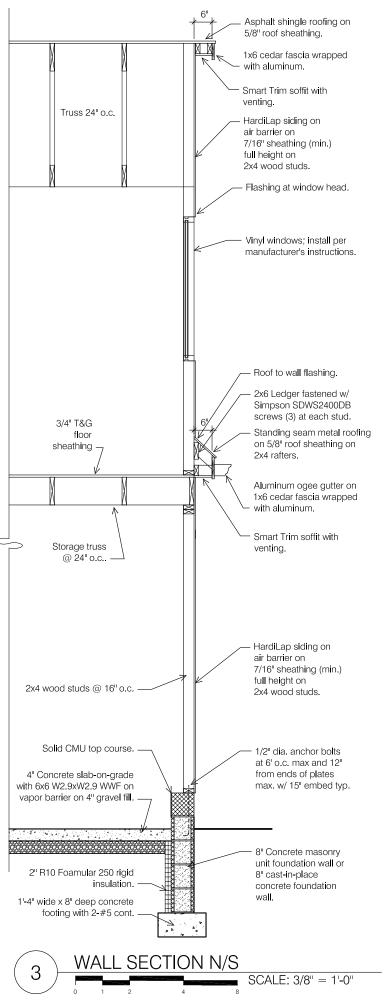

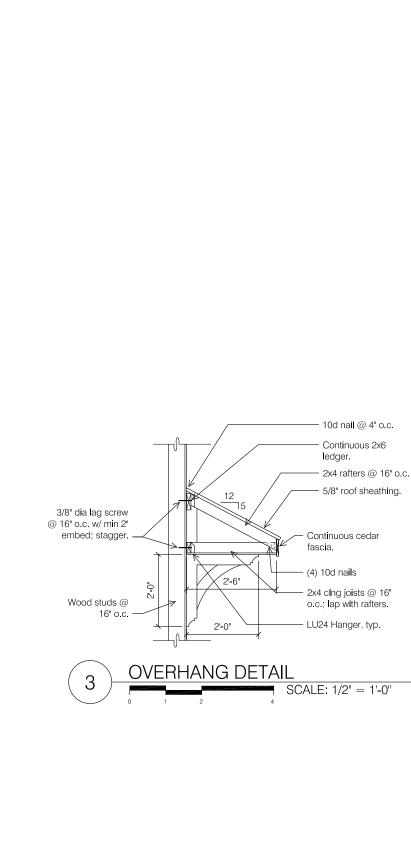

Architect:
Brenda Parker
614-586-5514



NEW DETACHED GARAGE 2700 SHERWOOD ROAD BEXLEY, OHIO 43209

Permit Set

SCALE:
As Noted

PROJECT NO.:


DATE: March 15, 2020

SHEET NO.

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SECTIONS



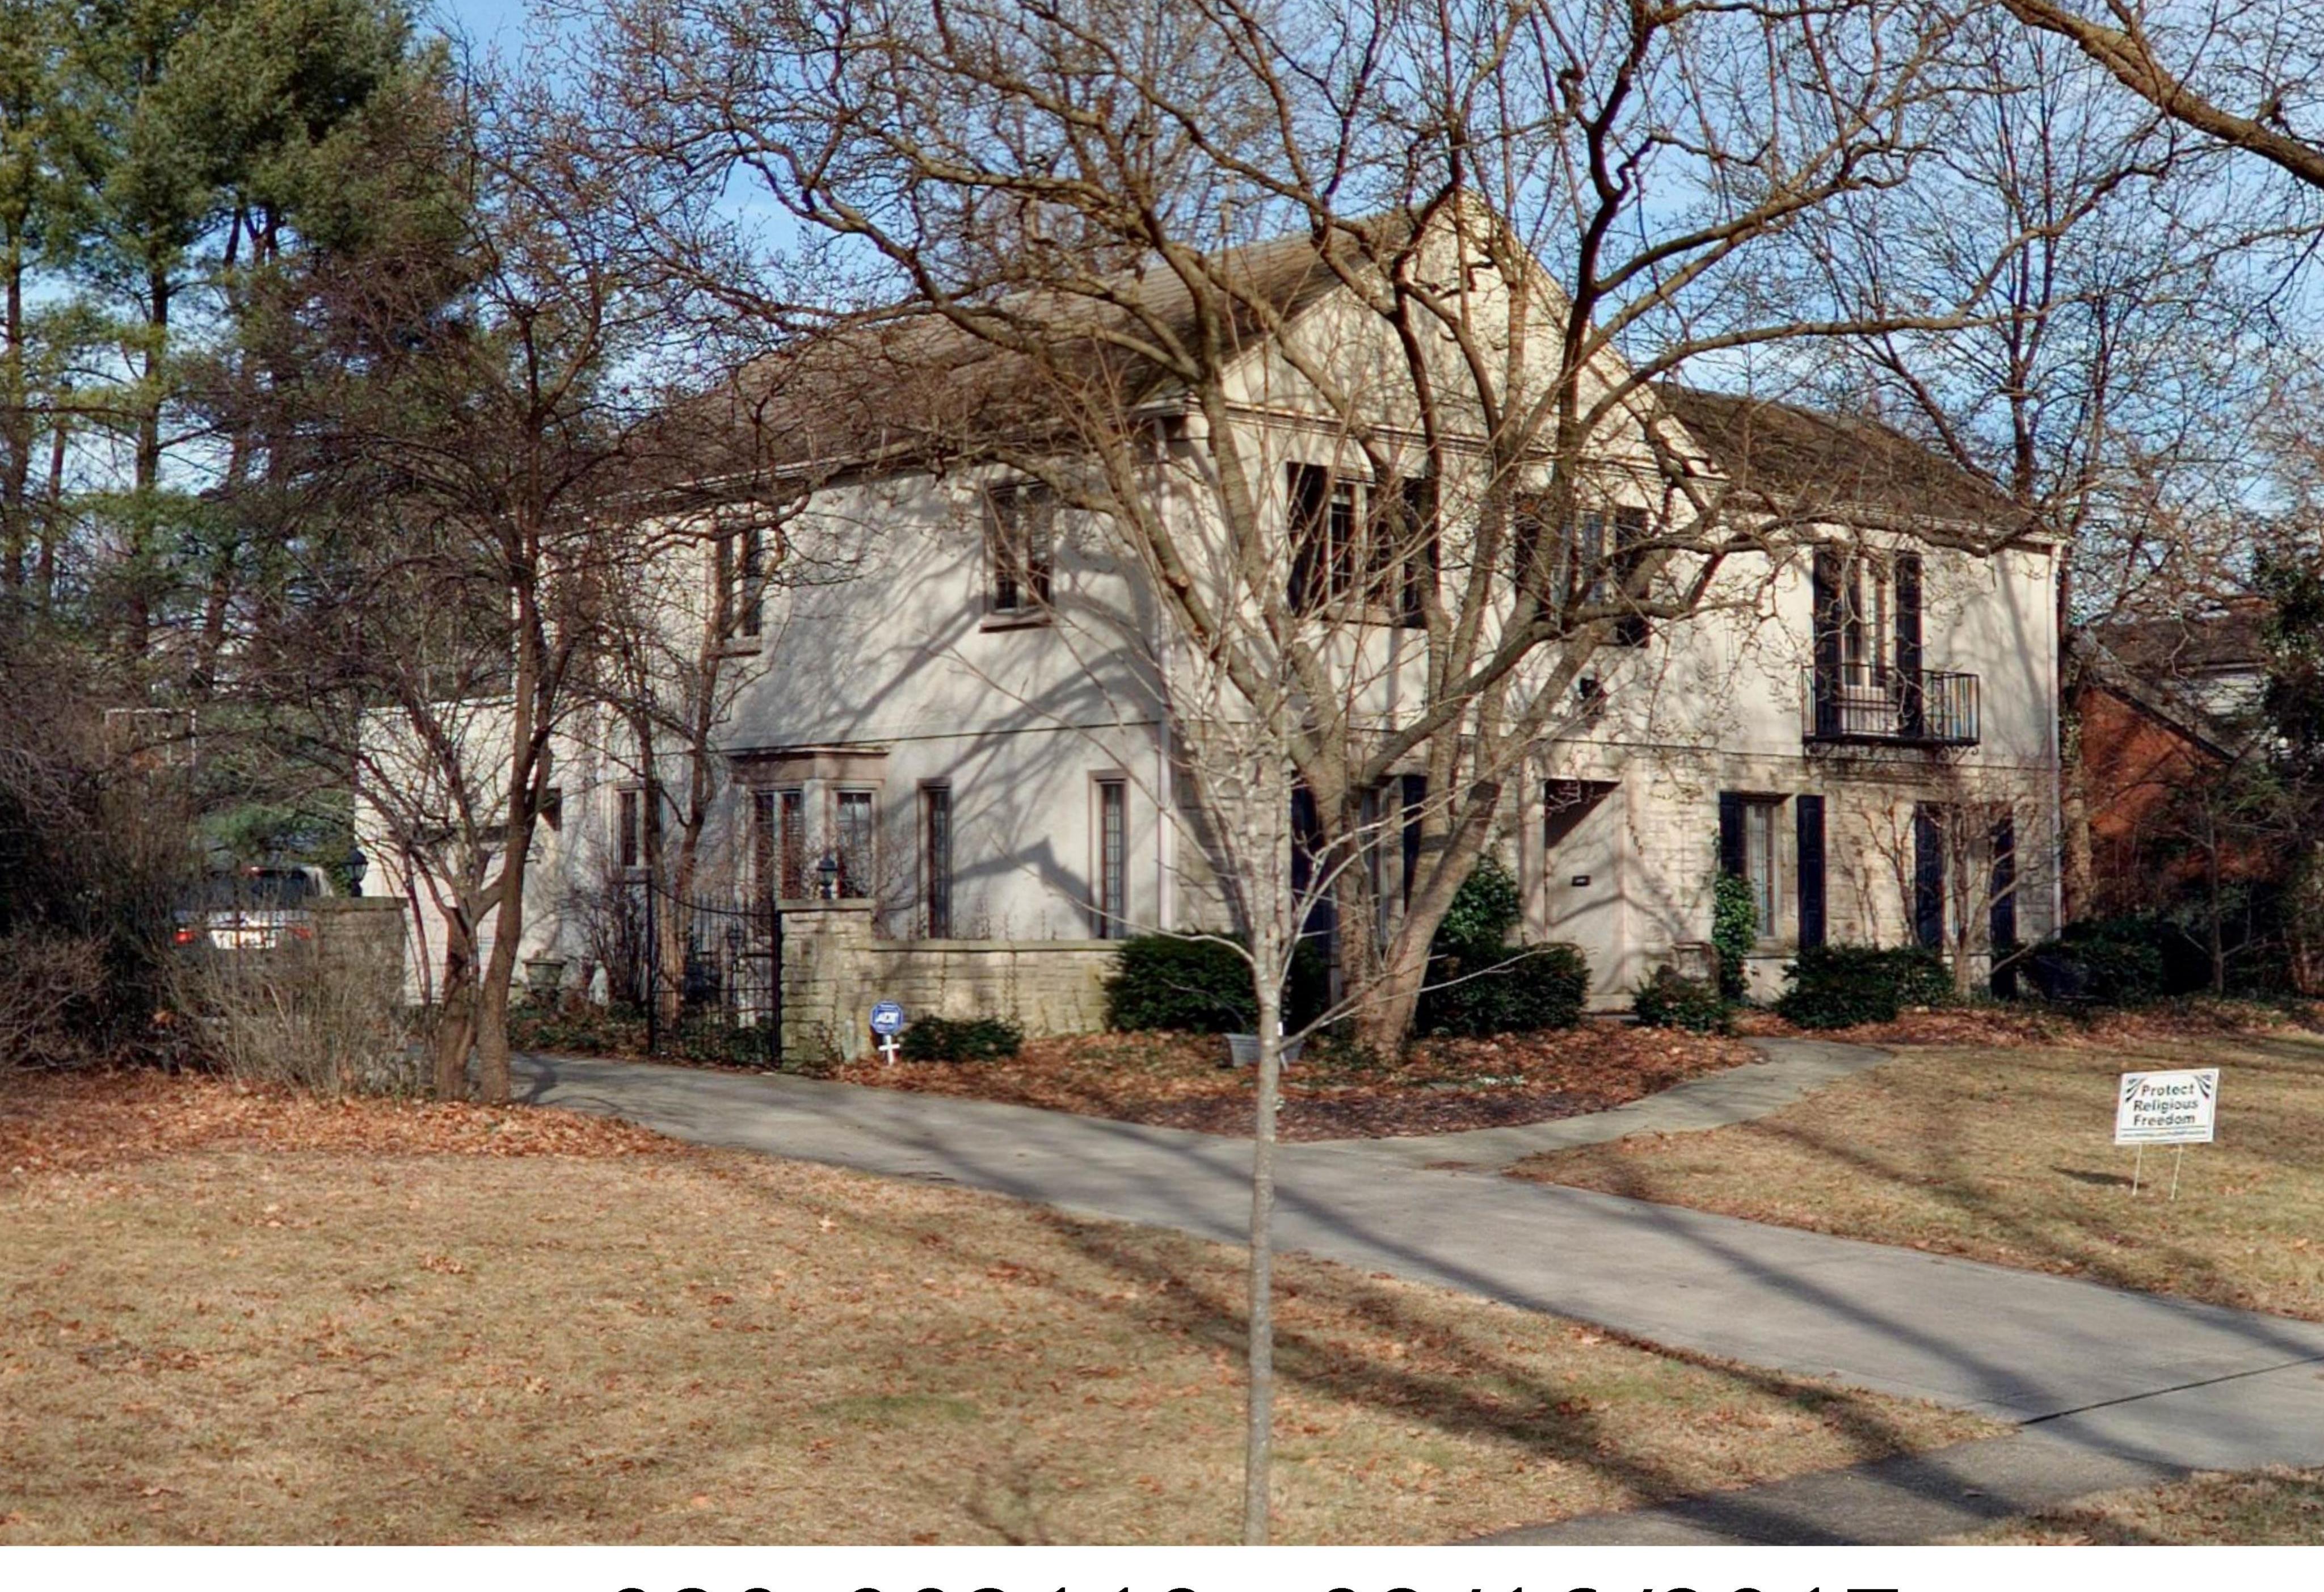

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