

Application Cover Sheet: Basic Project Information & Certification

Purpose of Application (check all that apply): Architectural Review Conditional Use Demolition Planned Unit Dev. Rezoning Landscape Review **Property & Project Information:** Property Address: tanwood **Brief Project Description:** Applicant Information: Applicant Name: Applicant Address: Applicant Email & Phone: **Property Owner Information:** Owner Name: Owner Address: Owner Email & Phone: Attorney/Agent Information: Agent Name: Agent Address: Agent Email & Phone: **Completed Worksheets:** Project Worksheet (Sheet A) Architectural Review (Sheet B) Signatures: The attached application package is complete and accurate to the best of my knowledge. I understand that the City staff review of this application is dependent upon the accuracy of the information provided and that any inaccurate or inadequate information provided by me/my firm/etc. may delay review. Applicant Signature: Date: Owner Signature: Date: Agent Signature: Date: Internal Use: Application#: **Board Referalls:** ☐ ARB BZAP City Council Tree Commission Staff Signature: Date:

CITY OF BEXLEY UNIFIED PLANNING APPLICATION

Project Worksheet Residential Commercial Property Address: tarmood **Zoning District:** R-1 (25% Building & 40% Overall) R-6 (35% Building & 60% Overall) R-2 (25% Building & 50% Overall) R-12 (35% Building & 70% Overall) R-3 (25% Building & 50% Overall) Other: * Overall coverage includes hardscape Lot Info: Width (ft.): Depth (ft.): Total Area (SF): **Primary Structure Info:** Existing Footprint (SF): Proposed Addition (SF): Removing (SF): (Type of Structure:) Proposed new primary structure or residence (SF): **Total Square Footage:** Garage and/or Accessory Existing Footprint (SF): New Structure Type: Structure Info (Incl. Decks, Pergolas, etc): Proposed Addition (SF): Ridge Height: Proposed New Structure (SF): Is there a 2nd floor? Yes Total of all garage and accessory structures (SF): 2nd Floor SF: Total building lot coverage (SF): % of lot Is this replacing an existing garage and/or accessory structure? **V** No Hardscape: Existing Driveway (SF): Existing Patio (SF): Existing Private Sidewalk (SF): Proposed Additional Hardscape (SF): Total Hardscape (SF): Totals: Total overall lot coverage (SF): % of lot Applicant Initial: Internal Use: Staff Review Date: Meets Zoning ARB Only Variance or Modifications Needed Staff Comments:

Staff Initial:

Architectural Review Worksheet

Design changes involving window, siding, roof replacement projects, detached garages, accessory structure, and deck construction may be reviewed and approved by the Design Consultant and/or Zoning officer, if it meets all zoning code requirements and maintenance improvements conforming to the "SPECIF-IC STANDARDS" in the Residential Review District Residential Design Guidelines. It may be directed to the Architectural Review Board or Board of Zoning and Planning for review and/or approval, if required by staff. Design approval is required in order to obtain a Building Permit. Work performed prior to an approval is subject to triple fees.

Please provide photos of the existing structure with this form Please indicate the existing materials and the proposed changes of exterior materials to be used in the completion of your design project. Check all that apply in each category below: House or Principal Structure Garage Only Roofing House & Garage **Existing Roof Type:** Slate Clay Tile Wood Shake Std. 3-tab Asphalt Shingle Arch. Dimensional Shingles EPDM Rubber TPO Rubber Metal New Roof Type: Clay Tile Wood Shake Std. 3-tab Asphalt Shingle Arch. Dimensional Shingles EPDM Rubber TPO Rubber Metal New Shingle Manufacturer: New Roof Style & Color: Windows House or Principal Structure Garage Only House & Garage **Existing Window Type:** Casement Fixed Exterior Storm Other: Double Hung Awning Horizontal Sliding **Existing Window Materials:** Aluminum Clad Wood Wood Metal Vinyl Clad Wood Aluminum Other: **New Window Manufacturer:** New Window Style/Mat./Color: House or Principal Structure Doors Garage Only House & Garage **Existing Entrance Door Type:** Wood Insulated Metal Fiberglass Sidelights Transom Windows **Existing Garage Door Type:** Insulated Metal Wood **Fiberglass** Door Finish: Stained X Painted Proposed Door Type: Style: w37,0 X Exterior Trim **Existing Door Trim:** Cedar Redwood Pine Std. Lumber Profile Wood Composite Aluminum Clad **Vinyl** Molding Other: Proposed New Door Trim: **Existing Window Trim:** Wood Redwood Pine Std. Lumber Profile Vinyl Other: Proposed New Window Trim: Trim Color(s): Do the Proposed Changes Affect the Overhangs? No


Architectural Review Worksheet (Continued)

Existing	Proposed	Туре:	Manfacturer, Style, Color:
区		Natural Stone	Ime stand
		Cultured Stone	
		Brick	
		Mortar	
X		Stucco	LWhite
		Wood Shingle	
		Wood Siding	
凶	S	Vinyl Siding	White to match (e)
		Aluminum Siding	
		Other	

Confirmation (to be complet	≥d by Residentia	al Design Consu	ltant:		
Date of Review:					
Approved By:					
To be reviewed by ARB on:					
Conditions/Stipulations:) 				·
Staff Initials:					Minimum and a

ALUM.	Adjustable Aluminum Anchor Bolt	KIT.	Kitchen
_	Angle		
	Approximate	L.V.L.	Laminated Vineer Lumb
	Asphalt	LAV. Lin.	Lavatory Linen
AWN.	Awning	LIN. LIV.	Linen Living
		L.S.	Lazy Susan
2017			•
	Basement Bearing		
	Between	MAX.	Maximum
	Block	MBR.	Master Bedroom
	Blocking	M.C.	Medicine Cabinet
	Board	MICRO.	Microwave
	Bottom	MIL. MIN.	.001 inch Minimum
BLDG.	Building	Milsc.	Miscellaneous
		M.O.	Masonary Opening
CANIT	Cantilaria		
	Cantilever Ceiling Joist		
	Ceiling	NO.	Number
CEIL.	Ceiling	N.T.S.	Not To Scale
	Ceramic	N.I.C.	Not In Contract
	Chimney		
	Concrete Mansonary Unit Cased Opening		
	Combination	0.C.	On Center
	Compact	O.H.D.	Over Head Door
	Concrete	OPNG.	Opening
	Cased Ceramic Tile	OPP O.D.	Opposite Outside Diameter
	Cabinet	0.0.	Outside Diditietei
	Clean Out		
COL.	Column		
	Construction	P.C.	Pull Chain
	Continuous	PICT. POLY.	Picture Polyethylene
	Contractor Courses	PROJ.	Projection
ono.	Courses		, , o j eo
DBL.	Double	DAD	Dadina
	Detail	RAD. RAFT.	Radius Rafters
	Double Hung	REFER.	Refrigerator
	Diameter	RM.	Room
,	Dishwasher	R.O.	Rough Opening
= : ::	Down Dryer	R.S.	Rough Sawn
	Down Spout	REQ'D	Required
	Drawing	R R/W	Risers Right of Way
	Dimension	.,,	ingine or may
		SEC.	Second
EA.	Each	SHWR.	Shower
	Elevation	S.L.	Side Lite
	Entertainment	SLDR.	Slider
	Expansion	STA. STD.	Stationary
	Exterior Existing	STL.	Standard Steel
	Electric	STRUCT	Structural
F/G	Fiber Glass	T.C.	Trash Compactor
	Finished	T. & G.	Tounge & Grove
	Fixture	TRANS.	Transom
	Floor Joist	Trap.	Trapazoid
	Floor Flourescent	TYP.	Typical
	Footing		
	Foot		
FLRG	Flooring	U.L.	Underlayment
	Foundation	UNEX.	Unexcavated
FUR	Furring		
		WACU	W
		WASH. WD.	Washer Wood
	Galvanized	W.F.	Wide Flange
	Garbage Disposal	W.H.	Water Heater
	Glued & Nailed Gas Log Lighter	W.W.M	Welded Wire Mesh
	Glass Log Lighter		
	General	0	at
		@ ሬ-	Center Line
		⊮ 1R−1S	Property Line One Rod One Shelf
HDR.	Header	1R-1S 1R-2S	One Rod Two Shelves
HGT	Height	2R-2S	Two Rods Two Shelves
H.B.	Hose Bib	S4S	Surface Four Sides
11.0.		2S	Two Shelves
11.0.		5S	Five Shelves
п.Б.		65	Six Shelves
	Insulation	6S 2W	Six Shelves Two Wide
INSUL.	Insulation Interior	2W 3W	Two Wide Three Wide
INSUL. INT.	Interior	2W 3W 4W	Two Wide Three Wide Four Wide
INSUL.		2W 3W	Two Wide Three Wide

ABBREVIATIONS

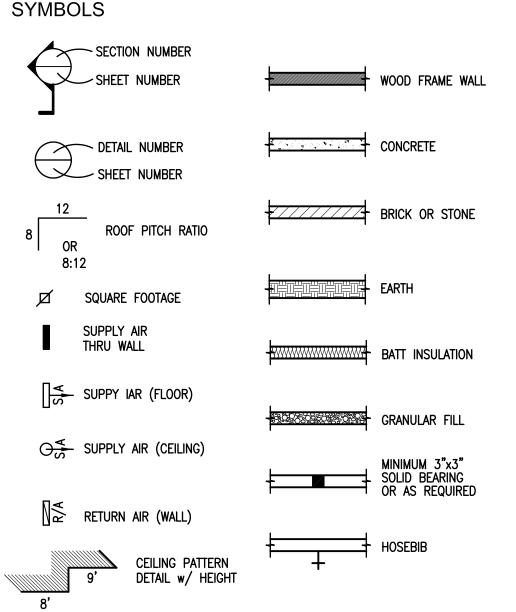

Home Addition For: lal Bendor & Nathan Render



E DWARDS RESIDENTIAL DESIGN

2437 SEVILLE STREET LANCASTER, OHIO 43130 PH/FX: (740) 654-6014 CELL: (740) 808-1180

EDWARDS RESIDENTIAL DESIGNS or Ron Edwards assumes no liability for any home constructed from this plan. Great care and diligence has gone into the preparation of the design and engineering of this plan. However this does not guarantee perfection; the contractor shall verify and be responsible for all conditions on the job. It is recommended that the purchaser of these plans consult a local architect or engineer of your choice, and check with your local code agency prior to start of actual construction. Changes made from these plans without the consent of the designer are unauthorized and shall relieve the designer of responsibility for all consequences arriving from such changes. Only a qualified designer, architect, contractor or structural engineer should attempt modifying any portion of this design.

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A101 EXTERIOR ELEVATIONS

A201 BASEMENT FOUNDATION PLAN

A301 FIRST FLOOR PLANS A302 SECOND FLOOR PLANS

A401 BUILDING SECTIONS, ROOF PLAN AND DETAILS

P101 PLUMBING PLANS M101 HVAC PLANS

E101 ELECTRICAL PLANS

CUSTOMER INFORMATION

TAL BENDOR AND NATHAN RENDER 110 S. STANWOOD ROAD BEXLEY, OHIO 43209

JOB SITE:

110 S. STANWOOD ROAD BEXLEY, OHIO 43209

BUILDING STATISTICS

CRAWL SPACE ADDITION:

373 SQ. FT.


FIRST FLOOR AREA: SECOND FLOOR AREA:

373 SQ. FT.

373 SQ. FT.

746 SQ. FT.

TOTAL FLOOR AREA:

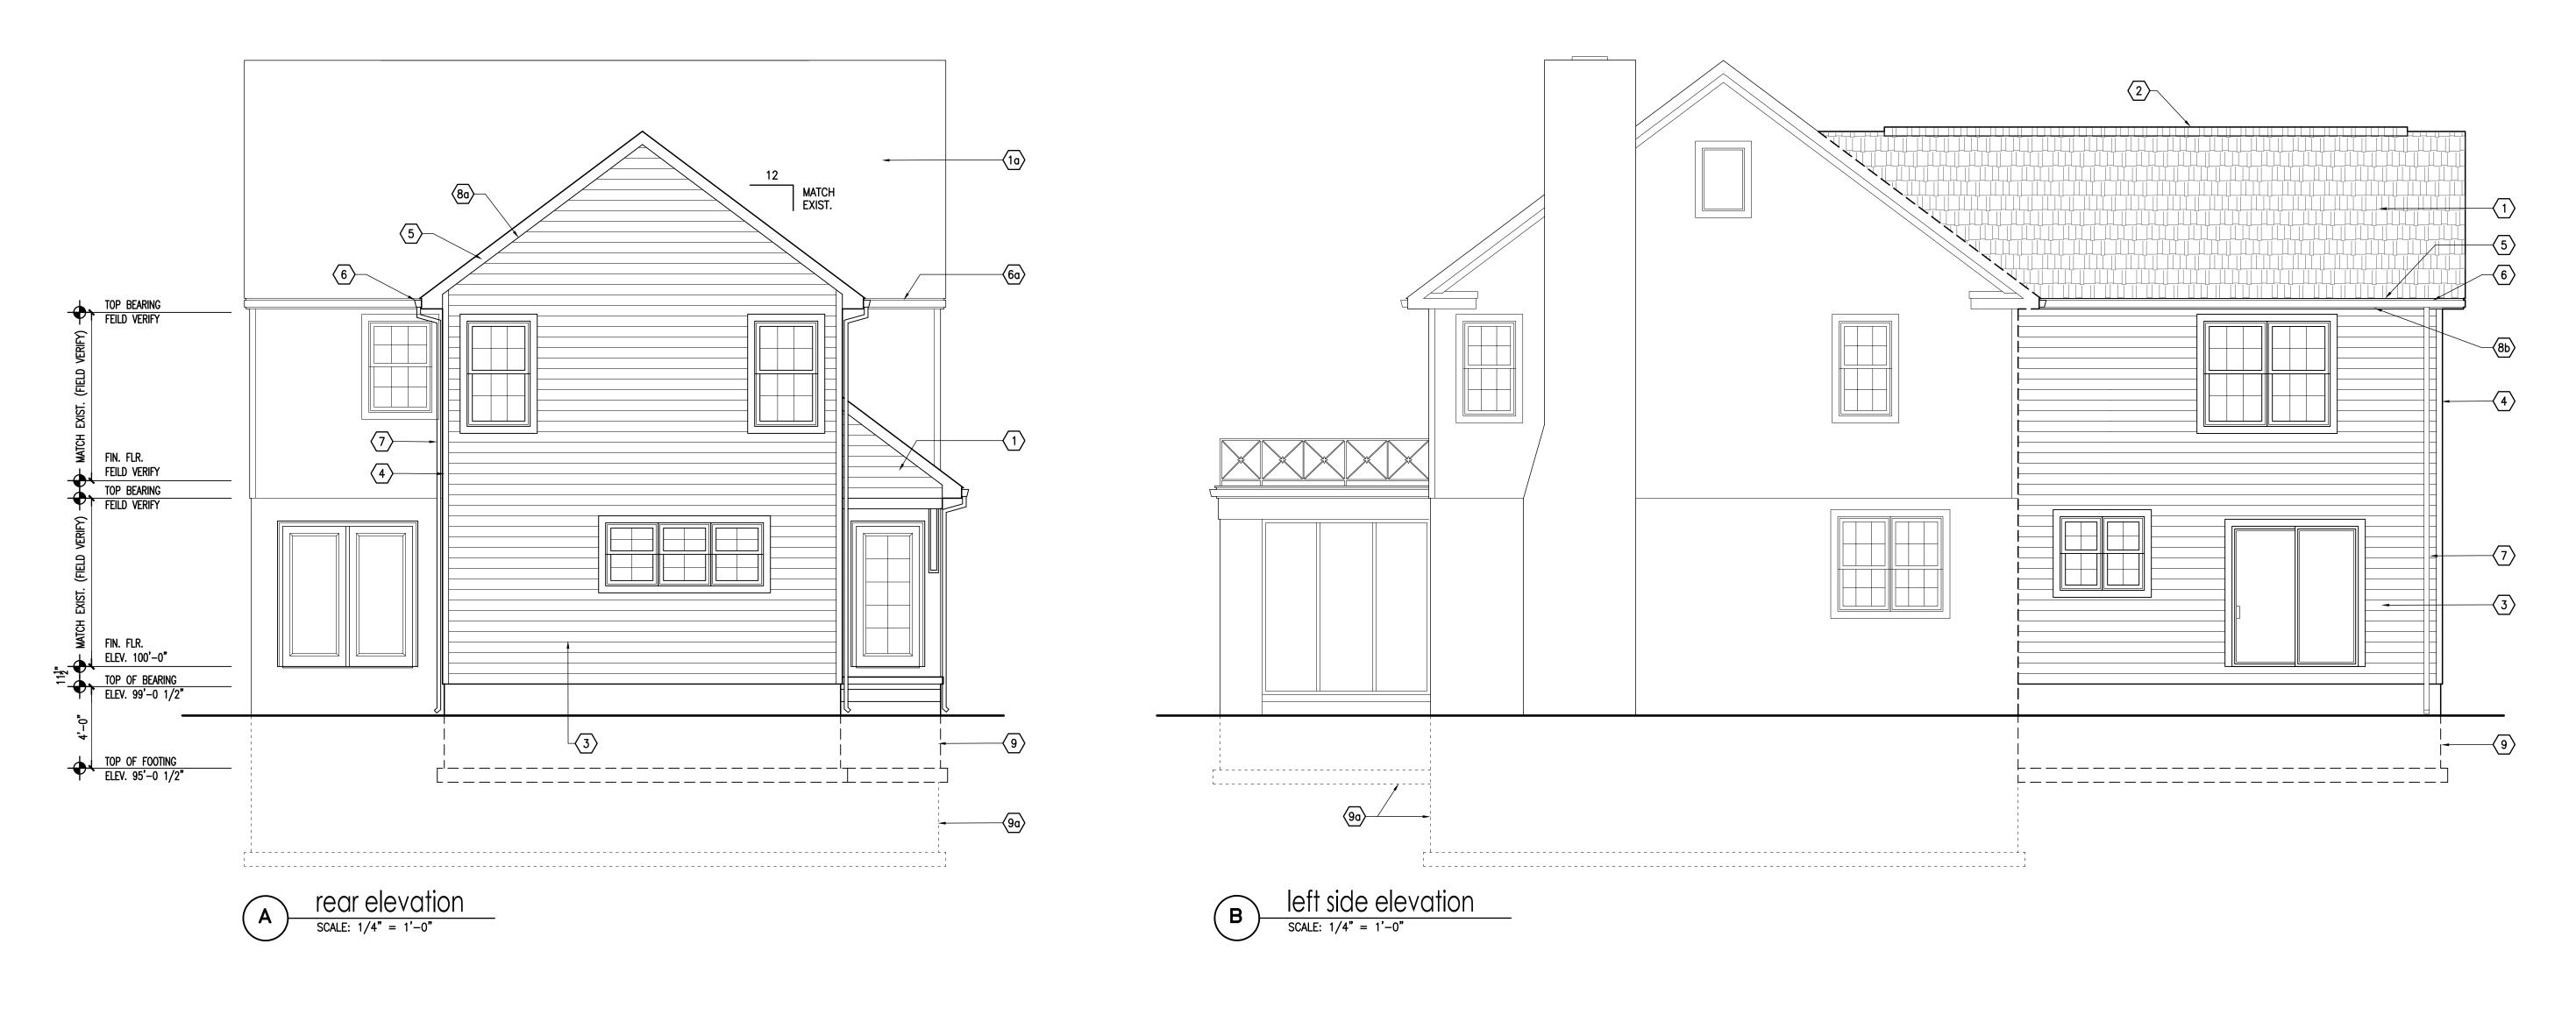

<u>___</u>



- 1. GUTTERS AND DOWNSPOUTS ARE NOT SHOWN FOR CLARITY. DOWNSPOUTS SHALL BE LOCATED TOWARDS THE FRONT AND REAR OF THE HOUSE. LOCATE DOWNSPOUTS IN AS NON-VISUALLY OFFENSIVE LOCATIONS AS POSSIBLE. FOR EXAMPLE: FRONT WALL OF HOUSE, BESIDE PORCH COLUMNS, ETC. GENERAL CONTRACTOR SHALL VERIFY EXISTING GRADES AND COORDINATE ANY NECESSARY ADJUSTMENTS TO THE HOUSE WITH OWNER.
- ATTIC TO LIMIT ROOF PENETRATIONS AND TO BE LOCATED AWAY FROM PUBLIC VIEW, I.E. AT THE REAR OF THE HOUSE
- REQUIREMENTS.
- 4. EXTERIOR FLASHING SHALL BE CORRECTLY INSTALLED AT ALL CONNECTIONS BETWEEN ROOFS, WALLS, CHIMNEYS, PROJECTIONS AND PENETRATIONS AS REQUIRED BY APPROVED CONSTRUCTION PRACTICES.
- 5. CONTRACTOR SHALL PROVIDE ADEQUATE ATTIC VENTILATION / ROOF VENTS PER LOCAL GOVERNING CODE. INSTALL CONTINUOUS RIDGE VENTILATION. PROVIDE PROPER SOFFIT VENTILATION AT OVERHANGS.

coded notes: \bigcirc

- CONTINUOUS RIDGE VENT.
- BY THE OWNER.
- 4. VINYL CORNER TRIM.
- a. RAKE SOLID VINYL SOFFIT PANELS
- 9. LINE OF NEW FOUNDATION WALL BELOW GRADE.
- 10. REMOVE AND RELOCATE EXISTING WINDOW AS SHOWN. SEE

- 2. PLUMBING AND H.V.A.C. VENTS SHALL BE GROUPED IN
- 3. PROVIDE ATTIC VENTILATION PER LOCAL CODE



- 1. FIBERGLASS ASHPALT SHINLGES OVER 15# FELT OVER 7/16" O.S.B. SHINGLE COLOR AS SELECTED BY THE OWNER.

 a. EXISTING SLATE ROOF SHINGLE TO REMAIN.
- INSTALL NEW HORIZONTAL LAP VINYL SIDING. COLOR AS SELECTED
- 5. METAL FASCIA TRIM OVER 2x TRIM BOARD.
- 6. INSTALL NEW METAL GUTTERS. a. REMOVE AND REPLACE EXISTING METAL GUTTERS
- 7. INSTALL NEW METAL DOWN SPOUTS.
- 8. INSTALL VINYL SOFFIT.
- b. EAVE VENTED VINYL SOFFIT PANELS
- a. APPROX. LINE OF EXISTING FOUNDATION BELOW GRADE
- SECOND FLOOR PLAN SHEET A302.

11. 36" HIGH HANDRAIL MINIMUM, VERT. BALUSTERS 4" MIN.

SHEET NUMBER

DRAWING TITLE:

EXTERIOR ELEVATIONS

E DWARDS RESIDENTIAL

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PROJECT

TAL BENDOR AND

110 S. STANWOOD ROAD COLUMBUS, OHIO 43209

NATHAN RENDER

JOB SITE:

110 S. STANWOOD ROAD COLUMBUS, OHIO 43209

JOB NUMBER:

1908

DATE:

05/12/19

R.L.E.

STAFF SCALE:

DRAWN:

CHECKED:

AS NOTED

REVISIONS:

(5)—

TOP BEARING FEILD VERIFY

FIN. FLR.

FEILD VERIFY


FIN. FLR.

TOP OF BEARING
ELEV. 99'-0 1/2"

TOP OF FOOTING
ELEV. 95'-0 1/2"

ELEV. 100'-0"

FEILD VERIFY TOP BEARING

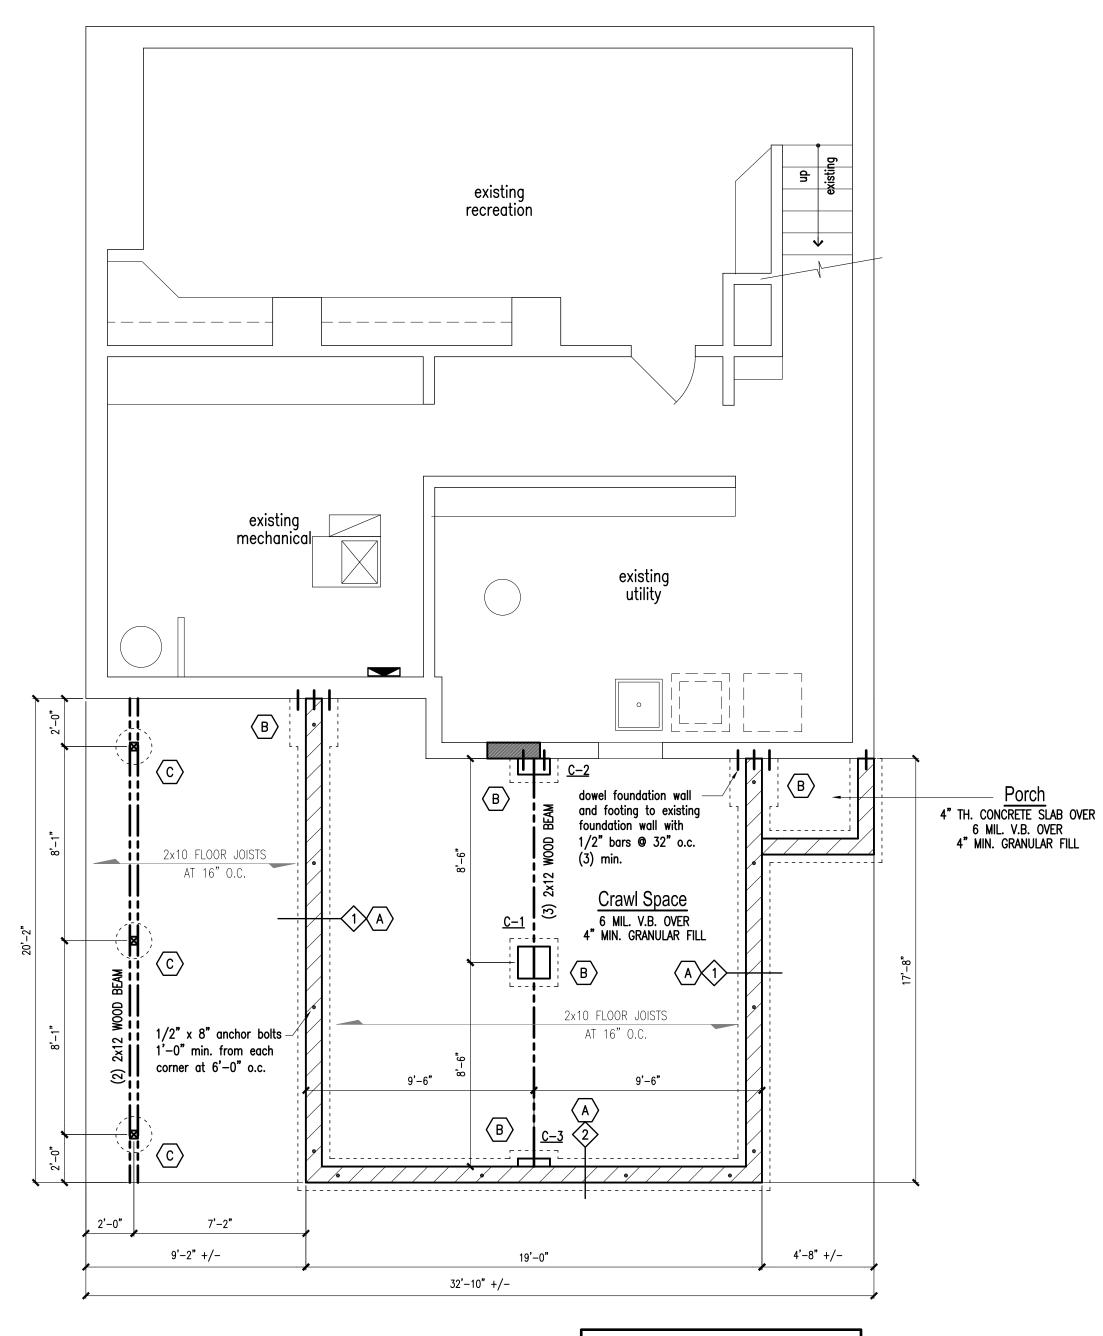

A BASEMENT FOUNDATION PLAN

SCALE: 1/4" = 1'-0"

NOTE:
GENERAL CONTRACTOR SHALL FIELD VERIFY ALL
EXISTING FLOOR ELEVATION AND FOUNDATION
FOOTING ELEVATION BEFORE BEGINING
CONTRUCTION.

construction & framing notes:

1. DESIGN LOADS ARE AS FOLLOWS PER SQ. FT. (IF APPLICABLE)

LOCATION 1ST FLOOR ATTIC (NO STORAGE) ATTIC (STORAGE) ROOF (WITH FINISHED CEILING)	LIVE LOAD 40 LB 10 LB 20 LB 30 LB (SNOW)	DEFLECTION 1 L/360 L/240 L/240 L/240
ROOF (WITH FINISHED CEILING) ROOF (NO FINISHED CEILING) DECKS		

- 2. LUMBER SHALL BE SOUTHERN YELLOW PINE, HEM-FIR OR DOUGLAS-FIR-LARCH WITH Fb = 1450 AND E=1.6 MINIMUM.
- 3. ALL HEADERS SHALL BE FREE OF SPLITS, CHECK OR SHAKES.
- 4. FLOOR CONSTRUCTION TO BE 3/4" TONGUE AND GROOVE SUBFLOOR WITH FINISH MATERIAL OVER.
- 5. STAIR CONSTRUCTION SHALL BE MADE FROM (3) 3x12 STRINGERS, 2x OR 5/4" TREADS AND 3/4" THICK RISERS OR PRE-FABRICATED STAIR COMPONENTS.
- 6. ALL WOOD PLATES IN CONTACT WITH CONCRETE SHALL BE PRESSURE TREATED & SEALED WITH SILICONE.
- 7. "MICRO-LAM" BEAMS SHALL HAVE Fb = 2800 P.S.I. VERIFY WITH LOCAL CODES.
- 8. SPECIAL UPLIFT CONNECTORS AS INDICATED AT CANTILEVERED JOIST SHALL BE "SIMPSON STRONG—TIE" OR APPROVED EQUAL.
- 9. ALL STRUCTURAL STEEL SHALL CONFORM WITH ASTM SPECIFICATION A-36.
- 10. UNLESS NOTED OTHERWISE, PROVIDE A 2x PLATE FASTENED TO THE TOP FLANGE OF ALL STEEL BEAMS SECURELY FASTEN ALL CONNECTING RAFTERS AND JOISTS AS APPROVED BY GOVERNING CODES, UNLESS NOTED OTHERWISE.
- 11. FLOOR FRAMING LAYOUT SHALL BE COORDINATED WITH THE GENERAL AND H.V.A.C. CONTRACTORS TO PROVIDE ACCESS CHASES AND UNOBSTRUCTED RUNS FOR H.V.A.C. DUCT WORK. FLOOR TRUSS LAYOUT TO BE ENGINEERED BY TRUSS MANUFACTURER.
- 12. PROVIDE BRIDGING OR BLOCKING AT MIDSPAN OF JOISTS, RAFTERS AND TRUSSES MAXIMUM SPACING BETWEEN BEARING WALLS AND BLOCKING IS 8'-0"

foundation notes:

- 1. ALL FOOTINGS SHALL BEAR UPON VIRGIN, UNDISTURBED SOIL.
- 2. ASSUMED SOIL SHALL BE SAND OR GRAVEL WITH, MINIMUM TRACES OF DRY CLAY WITH A MINIMUM BEARING CAPACITY OF 2000 P.S.F.
- 3. UNLESS NOTED OTHERWISE, ALL SLAB ON GRADE CONCRETE SHALL BE 3000 P.S.I. (28 DAY COMPRESSIVE STRENGTH) CONCRETE ON 4" SAND OR GRAVEL BASE MINIMUM. INTERIOR SLABS SHALL BE PLACED ON 6 MIL VAPOR BARRIER.
- 4. INSTALL 1/2" EXPANSION JOINT MATERIAL BETWEEN ALL CONCRETE SLABS ON ADJOINING CONCRETE OF MASONRY WALLS OCCURRING IN UNHEATED INTERIOR SPACES OR AT EXTERIOR LOCATIONS.
- 5. FOOTING SIZES SHOWN ARE ONLY TYPICAL FOR STATED SOIL PRESSURES AND CONTINENT COMPACTION; WHICHEVER IS MORE RESTRICTIVE.
- 6. CONTRACTOR TO VERIFY FOOTINGS DEPTHS WITH LOCAL FROST REQUIREMENTS OR EXISTING SOIL CONDITIONS; WHICHEVER IS MORE
- 7. PROVIDE PROTECTION FROM TERMITES AS REQUIRED BY LOCAL CODE. GARAGE SLABS TO HAVE CONTROL JOINTS PROVIDED AT MID POINTS IN BOTH DIRECTIONS.
- 8. MASONRY VENEER SHALL BE ANCHORED WITH GALVANIZED CORRUGATED METAL BRICK WALL TIES, SPACED AT 16" O.C. HORIZONTALLY AND 24" O.C. VERTICALLY
- 9. PROVIDE 3/8" WEEP HOLES SPACED AT 48" O.C. WITHIN THE FIRST EXPOSED COURSE ABOVE GRADE.

	WALL LEGEND							
SYM.	DESCRIPTION	STRUCTURAL	WALL HEIGHT					
\bigcirc	8" CONCRETE BLOCK WALL	HORZ. REINF. AT 32" O/C	4'-0"					
$\langle \hat{\gamma} \rangle$	8" CONCRETE BLOCK WALL	N/A	2'-8"					
	2x4 WOOD STUDS AT 16" O.C.	N/A	Field Verify					

	FOOTING LEGEND
	FOOTING LEGEND
$\langle A \rangle$	8"x16" CONTINUOUS CONCRETE FOOTING WITH 2 - #4 BARS CONTINUOUS
B	24"x24"x8" CONCRETE PAD
©	8"x18" DIA. CONCRETE PAD

	COLUMN LEGEND
C-1	16 X 16 CONCRETE BLOCK PEIR
C-2	16 X 8 CONCRETE BLOCK PEIR
C-3	16 X 4 CONCRETE BLOCK PEIR

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PROJECT

TAL BENDOR AND NATHAN RENDER 110 S. STANWOOD ROAD COLUMBUS, OHIO 43209

JOB SITE: 110 S. STANWOOD ROAD COLUMBUS, OHIO 43209

JOB NUMBER:

05/12/19

DRAWN: R.L.E.

CHECKED: STAFF SCALE:


AS NOTED

REVISIONS:

DRAWING TITLE:
BASEMENT
FOUNDATION PLAN

SHEET NUMBER

A201

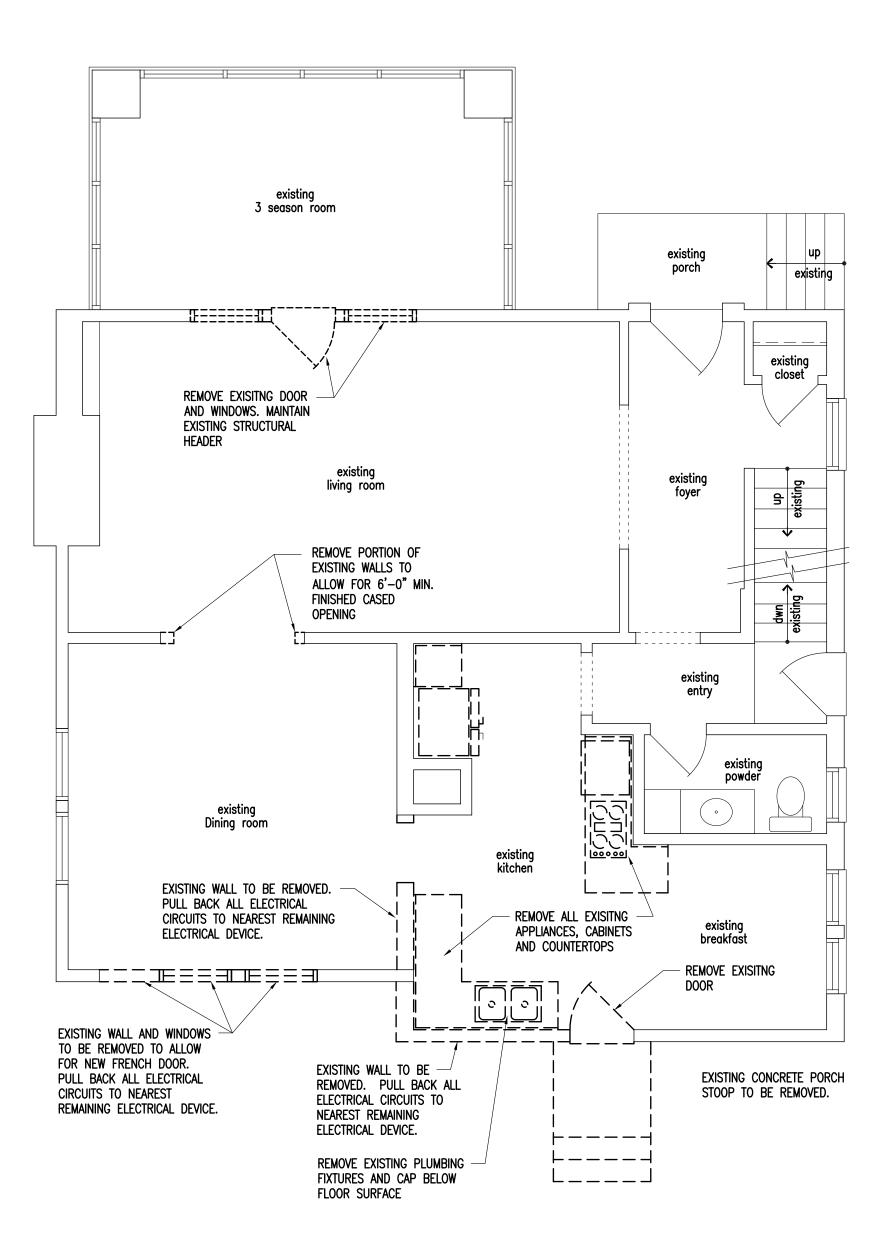

A FIRST FLOOR DEMOLITION PLAN

SCALE: 1/4" = 1'-0"

floor plan notes:

- 1. DO NOT SCALE ANY DRAWINGS IN THIS SET. FOLLOW THE DRAWINGS AS SHOWN ONLY. NOTIFY DESIGNER IF THEIR ARE ANY INCONSISTENCIES.
- STANDARD EXTERIOR WALLS ARE 2x6 UNLESS NOTED OTHERWISE ON DRAWINGS.
- STANDARD INTERIOR WALLS ARE 2x4 UNLESS NOTED OTHERWISE ON DRAWINGS.
- 4. STANDARD WALL HIEGHT IS 9'-1 1/8" ON FIRST FLOOR.
- 5. JOISTS, BEAMS & HEADERS SIZES ARE BASED ON # 1 S.Y.P.
- 6. CONTRACTOR SHALL FIELD VERIFY ALL DIMENSIONS BEFORE BEGINNING CONSTRUCTION.
- 7. ALL EXTERIOR WINDOWS AND DOOR HEADERS SHALL BE
 (2) 2x10'S w/ 1/2" PLYWOOD FILLER MINIMUM. UNLESS NOTED
 OTHERWISE ON THE DRAWINGS.
- 8. ALL ANGLED WALLS ARE TO BE 45 DEGREES UNLESS NOTED OTHERWISE ON THE DRAWINGS
- 9. PREFABRICATED FIREPLACES, WOODSTOVES, ETC ARE TO BE U.L. APPROVED AND INSTALLED PER THE MANUFACTURER'S WRITTEN SPECIFICATIONS.
- 10. PREFABRICATED FIREPLACE CONSTRUCTION SHALL MEET OR EXCEED ALL APPLICABLE CODES REGARDING USE OF FIRE SEPARATIONS AND CLEARANCES ETC. IT IS THE CONTRACTOR'S RESPONSIBILITY TO ENSURE THAT ALL ITEMS AND CONSTRUCTION MEET OR EXCEED CODE. OVERALL FLUE HEIGHT SHALL BE COORDINATED TO MATCH HEIGHT SHOWN ON PLANS AND SHALL NOT EXCEED THE TOP OF THE CHIMNEY CHASE AS CONSTRUCTED.


- 11. ALL DIMENSIONS ARE FROM FACE OF STUD TO FACE OF STUD UNLESS NOTED OTHERWISE ON THE DRAWINGS.
- 12. WINDOWS SIZES INDICATED ON THE PLANS ARE NOTED BY APPROXIMATE ROUGH OPENING SIZE, REFER TO PLANS AND EXTERIOR ELEVATIONS FOR WINDOW TYPES.
- 13. COORDINATE LOCATION OF UTILITY METERS WITH SITE PLAN AND LOCATE AWAY FROM THE VIEW OF THE PUBLIC. THE VISUAL IMPACT SHALL BE MINIMAL, I.E. MOUNT AS LOW AS POSSIBLE.
- 14. CONTRACTOR SHALL COORDINATE ALL CLOSET SHELVING REQUIREMENTS.
- 15. CONTRACTOR SHALL FIELD VERIFY ALL CABINET DIMENSIONS BEFORE FABRICATION.
- 16. BEDROOM WINDOW SHALL HAVE A MINIMUM NET CLEAR OPENING OF 5.7 SQ. FT. A MINIMUM NET CLEAR OPENABLE WIDTH OF 20". A MINIMUM NET CLEAR OPENABLE HEIGHT OF 24" AND HAVE A MAXIMUM FINISH SILL HEIGHT OF 43" FROM FINISH FLOOR.
- 17. ALL GLASS LOCATED WITHIN 18" OF FLOOR, 12" OF A DOOR OR LOCATED WITHIN 60" OF FLOOR AT BATHTUBS, WHIRLPOOLS, SHOWERS, SAUNAS, STEAM, ROOMS OR HOT TUBS SHALL BE TEMPERED.
- 18. ALL EXPOSED INSULATION SHALL HAVE A FLAME SPREAD RATING OF LESS THAN 25 AND A SMOKE DENSITY RATING OF LESS THAN 450.

- 19. PROVIDE COMBUSTION AIR VENTS, WITH SCREENS AND BACK DAMPER, FOR FIREPLACES, WOOD STOVES AND ANY APPLIANCES WITH AN OPEN FLAME.
- THE OUTSIDE WITH A MINIMUM OF A 75 CFM. FAN. RANGE HOODS SHALL ALSO BE VENTED TO THE OUTSIDE.

 22. WALLS COMMON TO GARAGE AND HOUSE HAVE (1) LAYER

20. BATHROOMS AND UTILITY ROOMS SHALL BE VENTED TO

- 22. WALLS COMMON TO GARAGE AND HOUSE HAVE (1) LAYER OF TYPE 'X' FIRE RATED GYPSUM BOARD ON GARAGE SIDE.
- 23. ALL FIREPLACE CHASE WALLS SHALL BE INSULATED INSIDE AND OUTSIDE. INSTALL HORIZONTAL "DRAFT STOPS" AT EACH FLOOR LEVEL BY PACKING 6" (R-19 MIN.) INSULATION BETWEEN JOISTS.
- 24. ALL INTERIOR WALL SHALL BE COVERED WITH 1/2" GYPSUM BOARD, WITH METAL CORNER REINFORCING. TAPE FLOAT AND SAND. (3 COATS) USE 5/8" GYPSUM BOARD ON CEILINGS WHEN SUPPORTING MEMBER ARE PLACED AT 24" O.C. OR GREATER. USE 1/2" GYPSUM BOARD WITH FRAMING MEMBERS ARE PLACED AT 16" O.C. OR LESS.
- 25. ALL BATH AND TOILET AREA WALLS AND CEILINGS SHALL HAVE WATER RESISTANT GYPSUM BOARD.

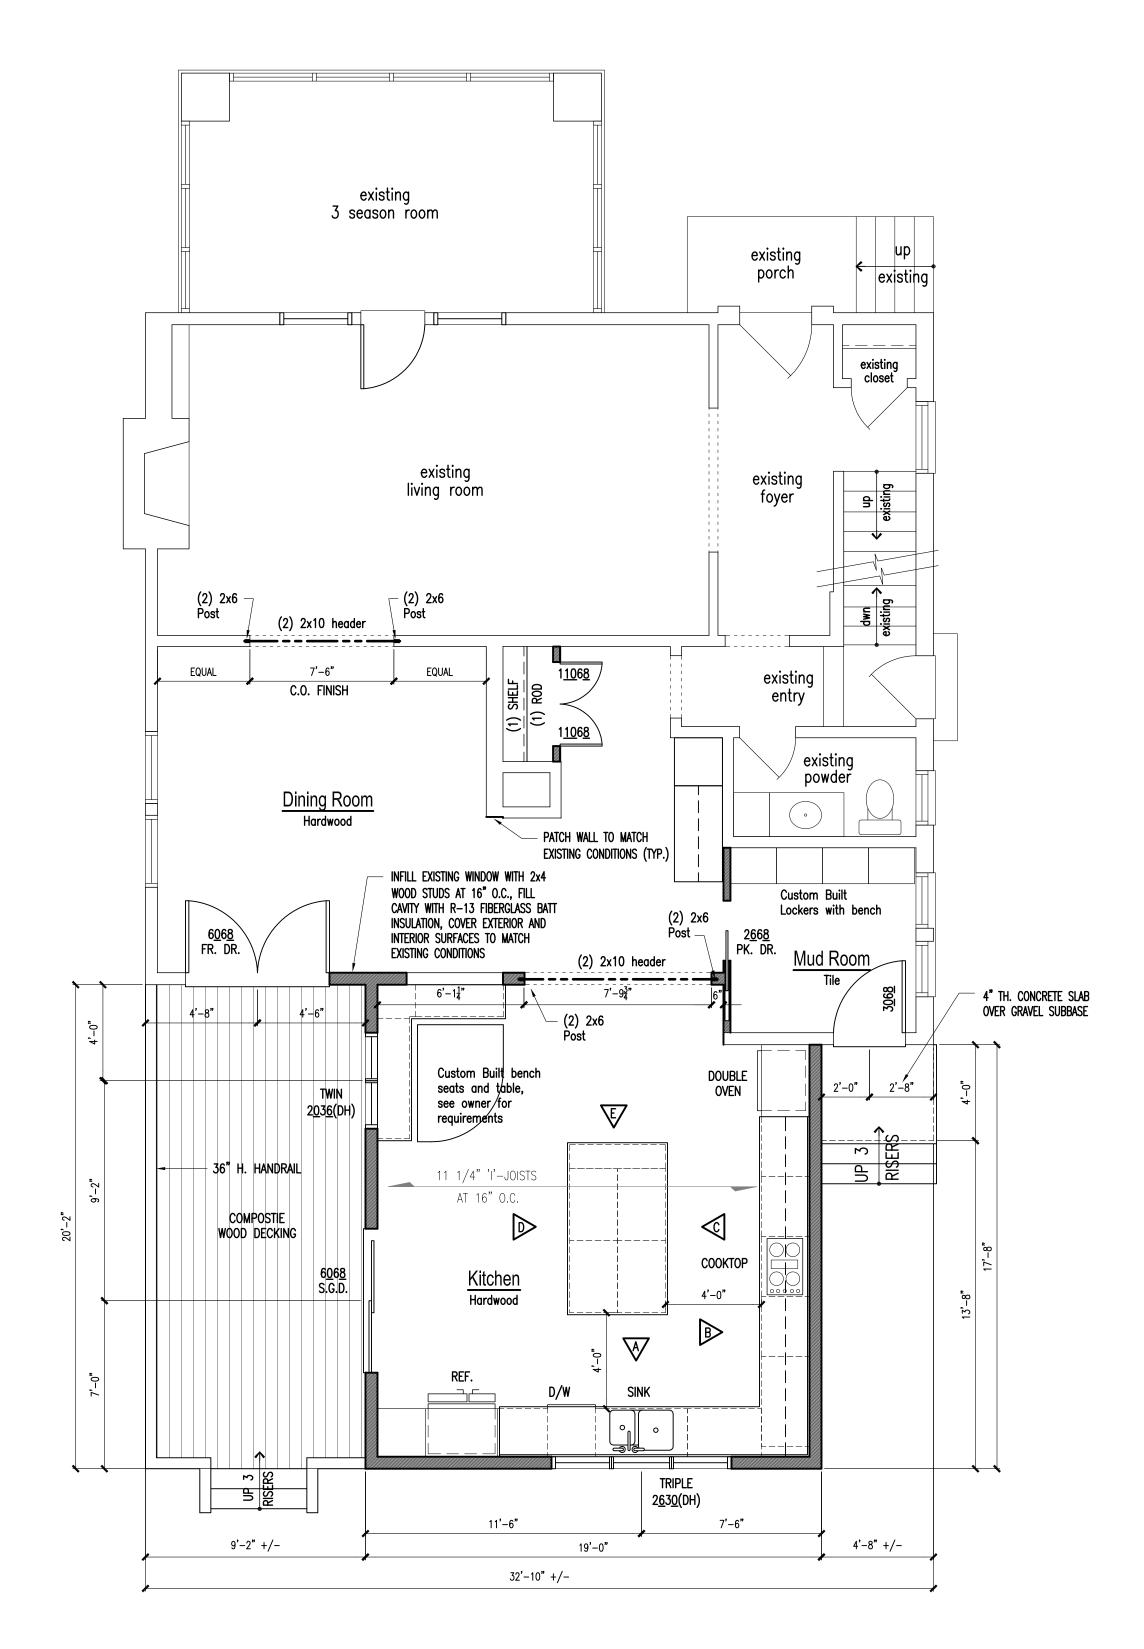

B FIRST FLOOR PLAN
SCALE: 1/4" - 1'-0"



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DRAWN: R.L.E.


CHECKED:

SCALE: AS NOTED

REVISIONS:

DRAWING TITLE:

A301

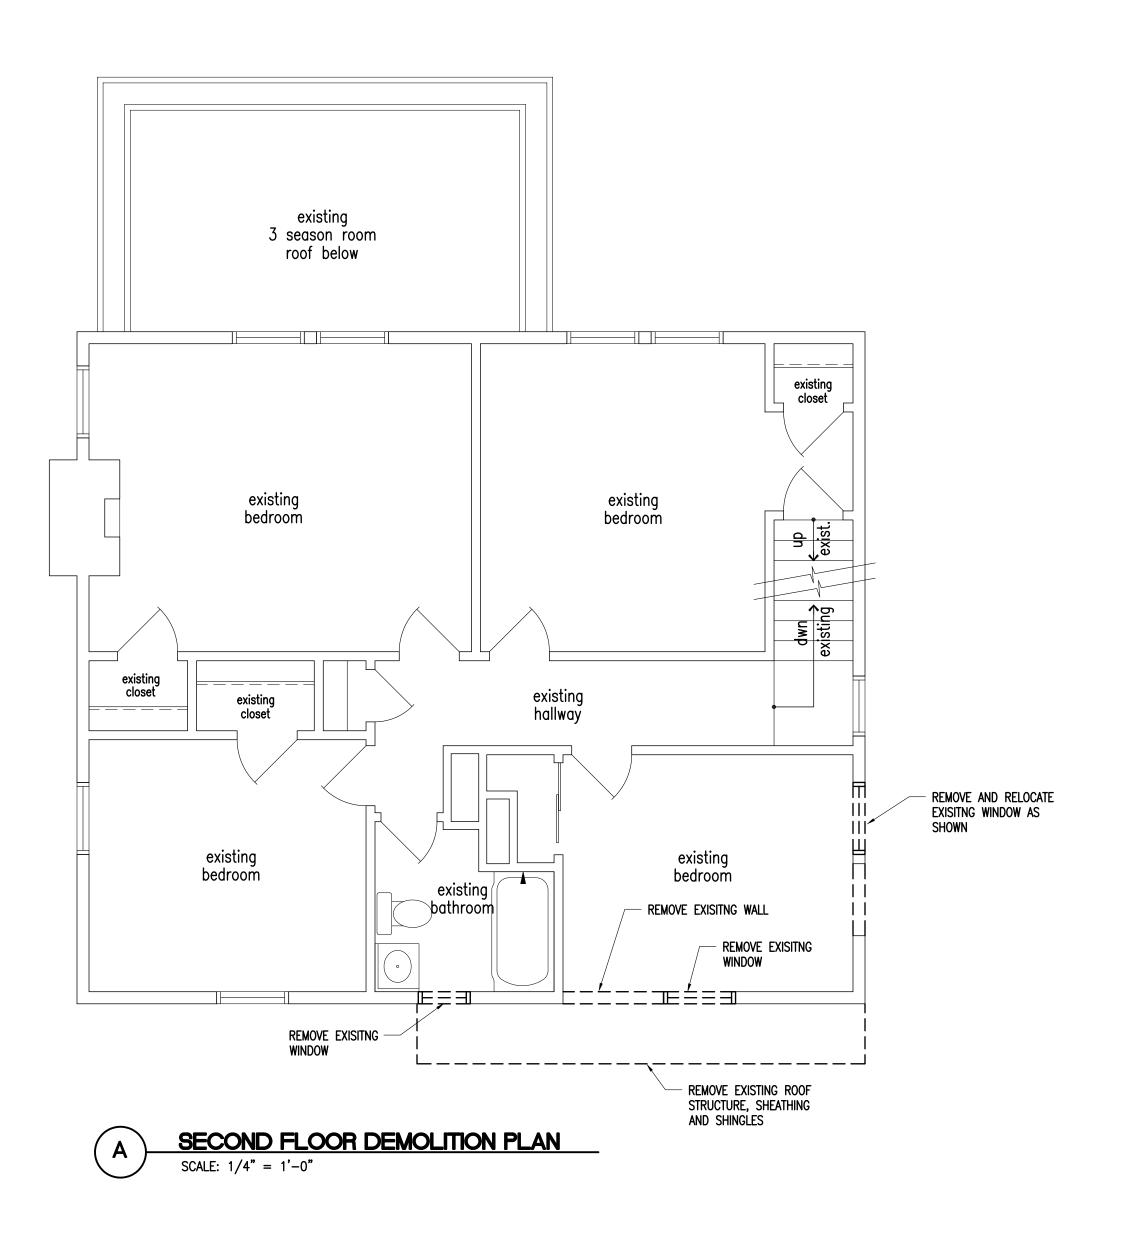

floor plan notes:


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- OTHERWISE ON DRAWINGS.

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- 6. CONTRACTOR SHALL FIELD VERIFY ALL DIMENSIONS BEFORE BEGINNING CONSTRUCTION.
- 8. ALL ANGLED WALLS ARE TO BE 45 DEGREES UNLESS NOTED OTHERWISE ON THE DRAWINGS
- 9. PREFABRICATED FIREPLACES, WOODSTOVES, ETC ARE TO BE U.L. APPROVED AND INSTALLED PER THE MANUFACTURER'S WRITTEN SPECIFICATIONS.
- 10. PREFABRICATED FIREPLACE CONSTRUCTION SHALL MEET OR EXCEED ALL APPLICABLE CODES REGARDING USE OF FIRE SEPARATIONS AND CLEARANCES ETC. IT IS THE CONTRACTOR'S RESPONSIBILITY TO ENSURE THAT ALL ITEMS AND CONSTRUCTION MEET OR EXCEED CODE. OVERALL FLUE HEIGHT SHALL BE COORDINATED TO MATCH HEIGHT SHOWN ON PLANS AND SHALL NOT EXCEED THE TOP OF THE CHIMNEY CHASE AS CONSTRUCTED.

- 11. ALL DIMENSIONS ARE FROM FACE OF STUD TO FACE OF STUD UNLESS NOTED OTHERWISE ON THE DRAWINGS.
- 12. WINDOWS SIZES INDICATED ON THE PLANS ARE NOTED BY APPROXIMATE ROUGH OPENING SIZE, REFER TO PLANS AND EXTERIOR ELEVATIONS FOR WINDOW TYPES.
- 13. COORDINATE LOCATION OF UTILITY METERS WITH SITE PLAN AND LOCATE AWAY FROM THE VIEW OF THE PUBLIC. THE VISUAL IMPACT SHALL BE MINIMAL, I.E. MOUNT AS LOW AS POSSIBLE.
- 14. CONTRACTOR SHALL COORDINATE ALL CLOSET SHELVING REQUIREMENTS.
- 15. CONTRACTOR SHALL FIELD VERIFY ALL CABINET DIMENSIONS BEFORE FABRICATION.
- 16. BEDROOM WINDOW SHALL HAVE A MINIMUM NET CLEAR OPENING
 OF 5.7 SQ. FT. A MINIMUM NET CLEAR OPENABLE WIDTH OF
 20". A MINIMUM NET CLEAR OPENABLE HEIGHT OF 24" AND
 HAVE A MAXIMUM FINISH SILL HEIGHT OF 43" FROM FINISH FLOOR.
- 17. ALL GLASS LOCATED WITHIN 18" OF FLOOR, 12" OF A DOOR OR LOCATED WITHIN 60" OF FLOOR AT BATHTUBS, WHIRLPOOLS, SHOWERS, SAUNAS, STEAM, ROOMS OR HOT TUBS SHALL BE TEMPERED.
- 18. ALL EXPOSED INSULATION SHALL HAVE A FLAME SPREAD RATING OF LESS THAN 25 AND A SMOKE DENSITY RATING OF LESS THAN 450.

- 19. PROVIDE COMBUSTION AIR VENTS, WITH SCREENS AND BACK DAMPER, FOR FIREPLACES, WOOD STOVES AND ANY APPLIANCES WITH AN OPEN FLAME.
- 20. BATHROOMS AND UTILITY ROOMS SHALL BE VENTED TO THE OUTSIDE WITH A MINIMUM OF A 75 CFM. FAN. RANGE HOODS SHALL ALSO BE VENTED TO THE OUTSIDE.
- 22. WALLS COMMON TO GARAGE AND HOUSE HAVE (1) LAYER OF TYPE 'X' FIRE RATED GYPSUM BOARD ON GARAGE SIDE.
- 23. ALL FIREPLACE CHASE WALLS SHALL BE INSULATED INSIDE AND OUTSIDE. INSTALL HORIZONTAL "DRAFT STOPS" AT EACH FLOOR LEVEL BY PACKING 6" (R-19 MIN.) INSULATION BETWEEN JOISTS.
- 24. ALL INTERIOR WALL SHALL BE COVERED WITH 1/2" GYPSUM BOARD, WITH METAL CORNER REINFORCING. TAPE FLOAT AND SAND. (3 COATS) USE 5/8" GYPSUM BOARD ON CEILINGS WHEN SUPPORTING MEMBER ARE PLACED AT 24" O.C. OR GREATER. USE 1/2" GYPSUM BOARD WITH FRAMING MEMBERS ARE PLACED AT 16" O.C. OR LESS.
- 25. ALL BATH AND TOILET AREA WALLS AND CEILINGS SHALL HAVE WATER RESISTANT GYPSUM BOARD.



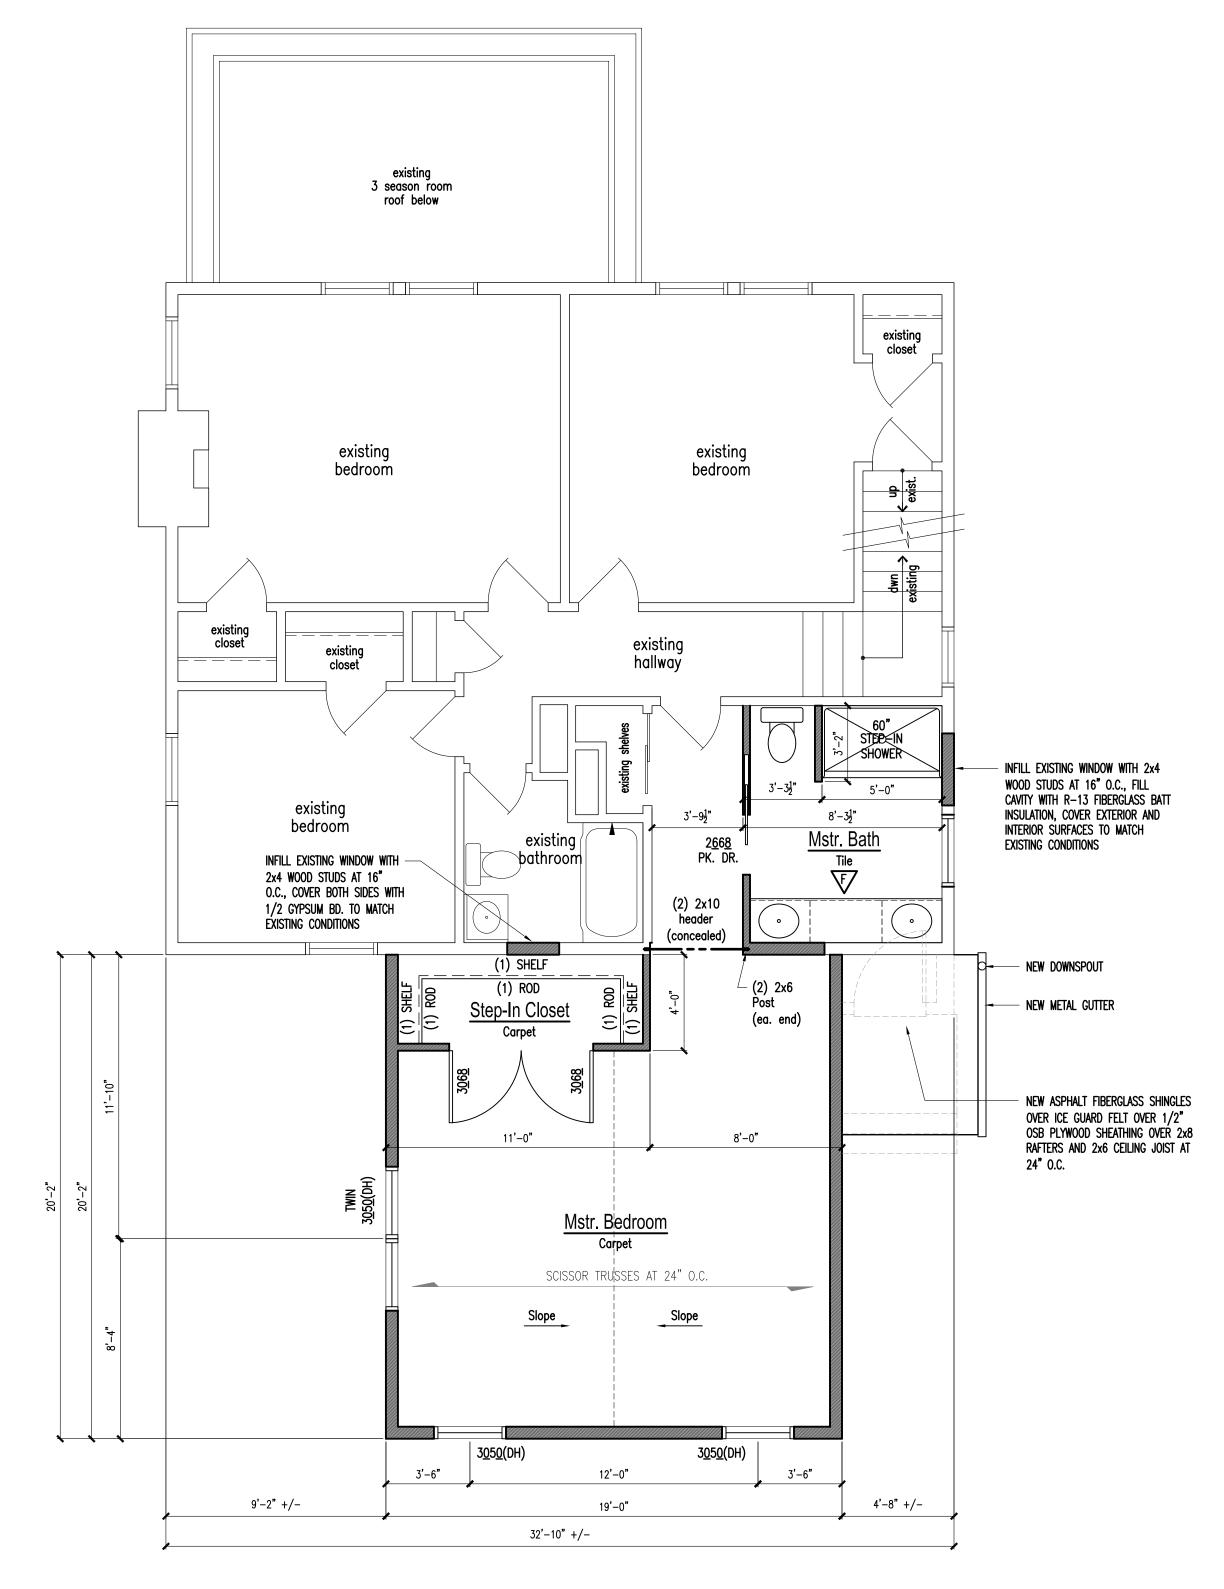

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RESIDENTIAL
DESIGN
2437 SEVILLE STREET
LANCASTER, OHIO 43130
PH/FX: (740) 654-6014
CELL: (740) 808-1180

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PROJECT

TAL BENDOR AND NATHAN RENDER 110 S. STANWOOD ROAD COLUMBUS, OHIO 43209

JOB SITE: 110 S. STANWOOD ROAD COLUMBUS, OHIO 43209

JOB NUMBER:

DATE: 05/12/19

DRAWN: R.L.E.

CHECKED: STAFF

SCALE:


AS NOTED

REVISIONS:

DRAWING TITLE: SECOND FLOOR PLAN


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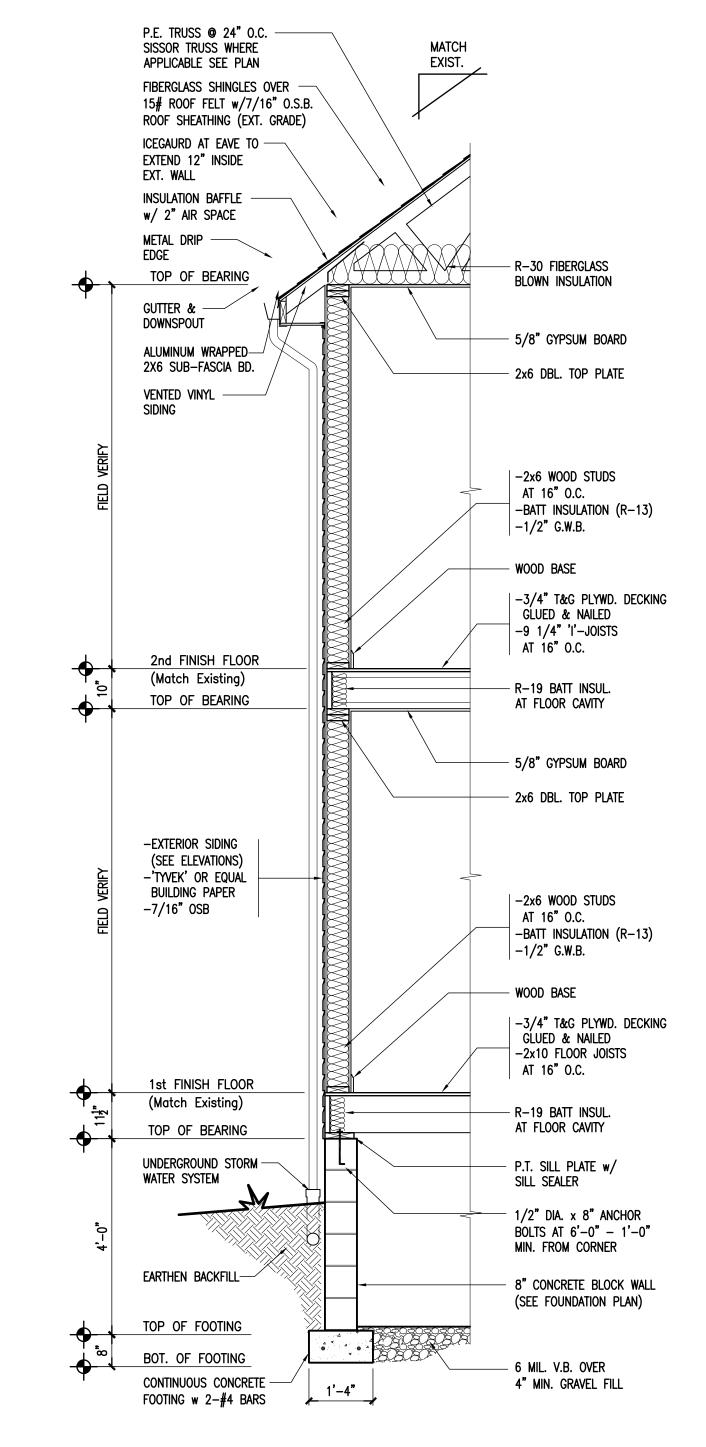
A302

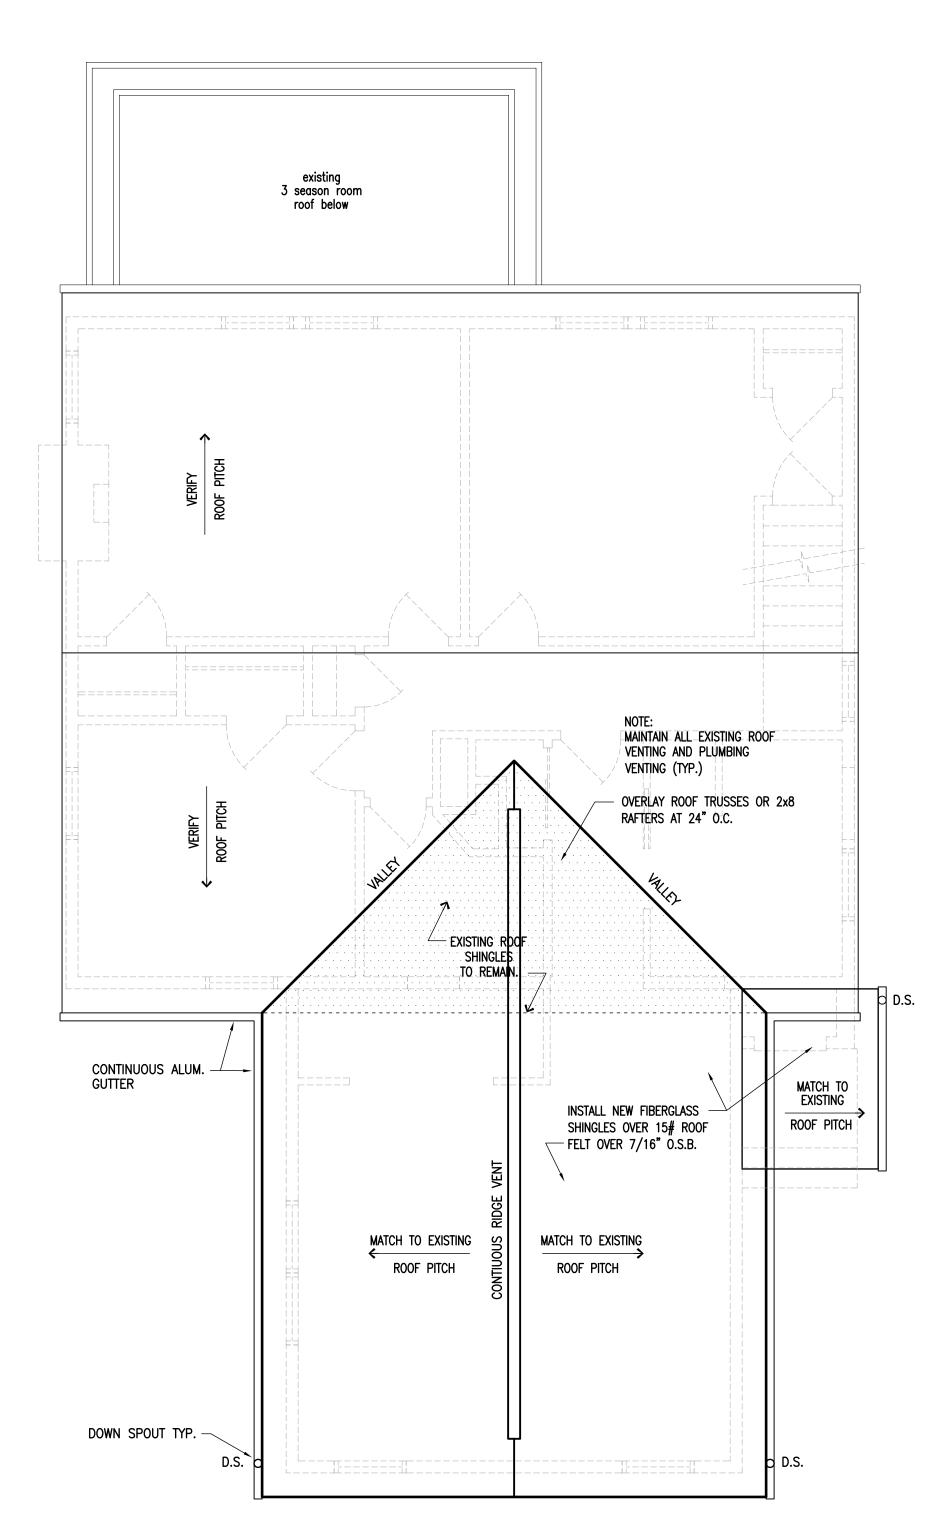

A ROOF PLAN

SCALE: 1/4" = 1'-0"



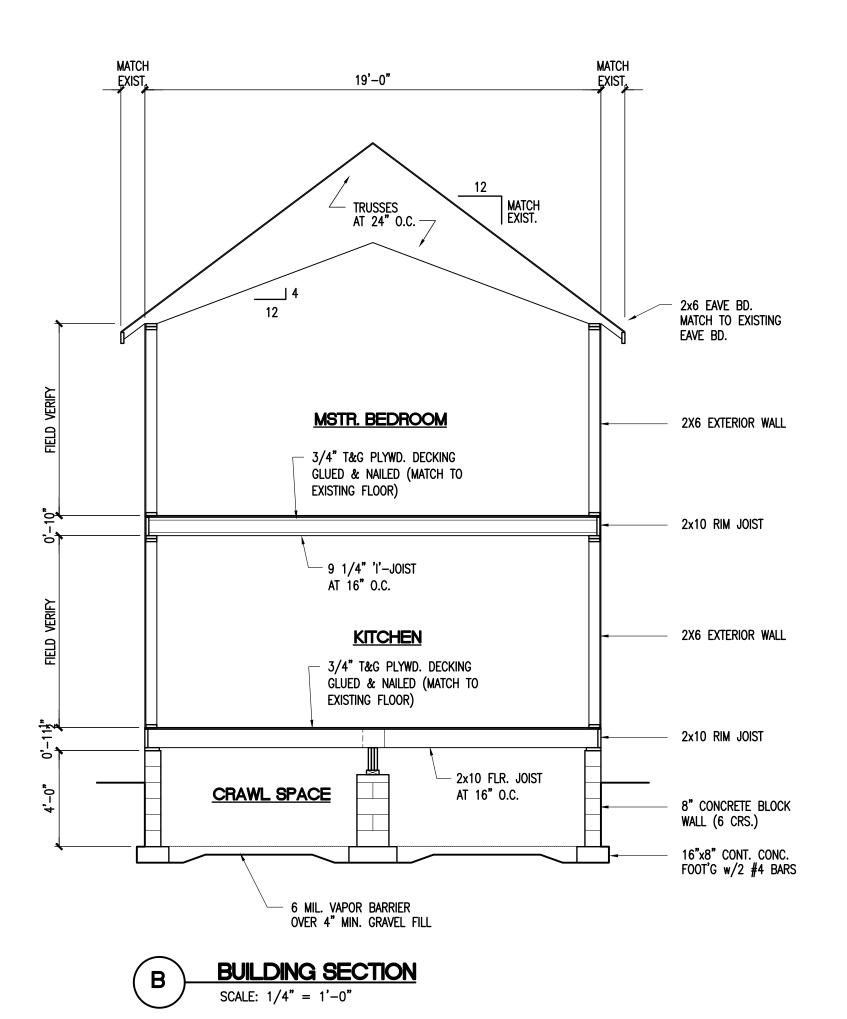

C TYP. WALL SECTION

SCALE: 1/2" = 1'-0"

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JOB SITE: 110 S. STANWOOD ROAD COLUMBUS, OHIO 43209

JOB NUMBER:

DATE: 05/12/19

DRAWN: R.L.E.

1908

CHECKED:

STAFF
SCALE:


AS NOTED

REVISIONS:

DRAWING TITLE:
BUILDING SECTIONS
ROOF PLAN
AND DETAILS


SHEET NUMBER

A401

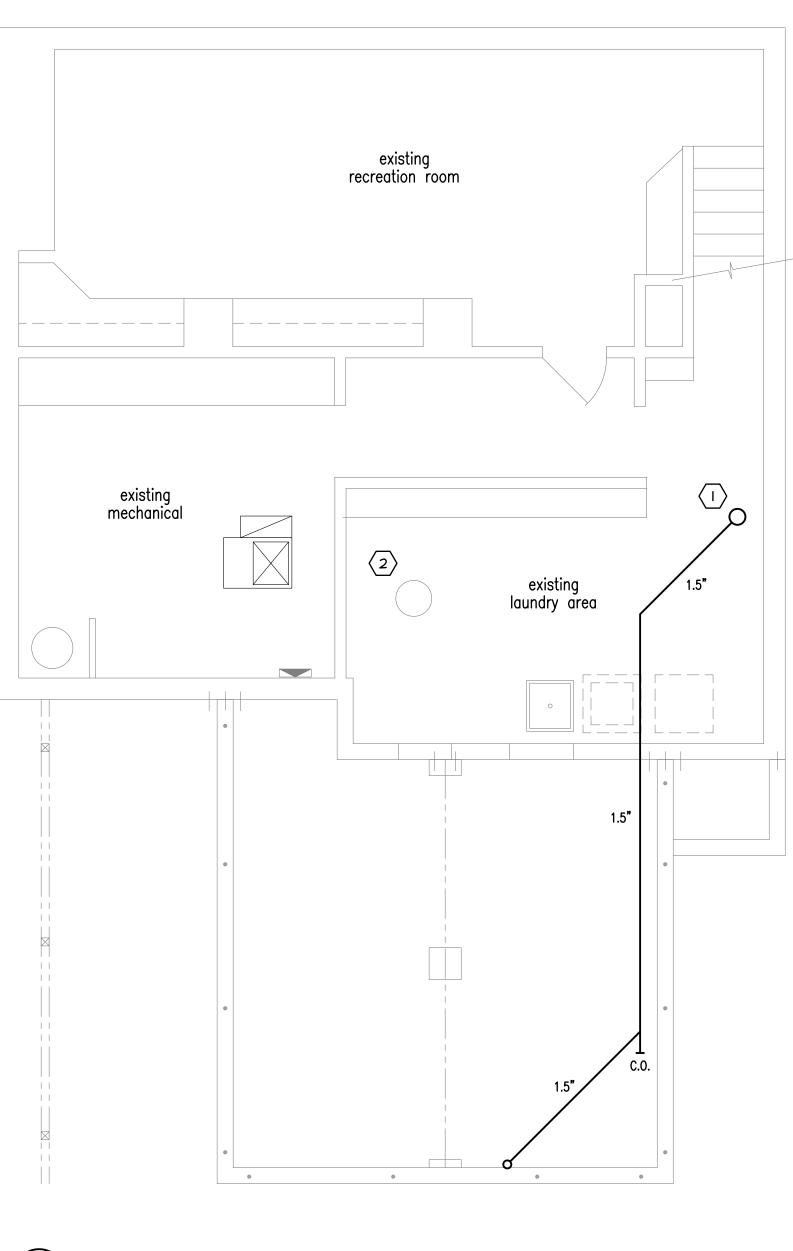

BASEMENT HVAC PLAN


SCALE: 1/4" = 1'-0"

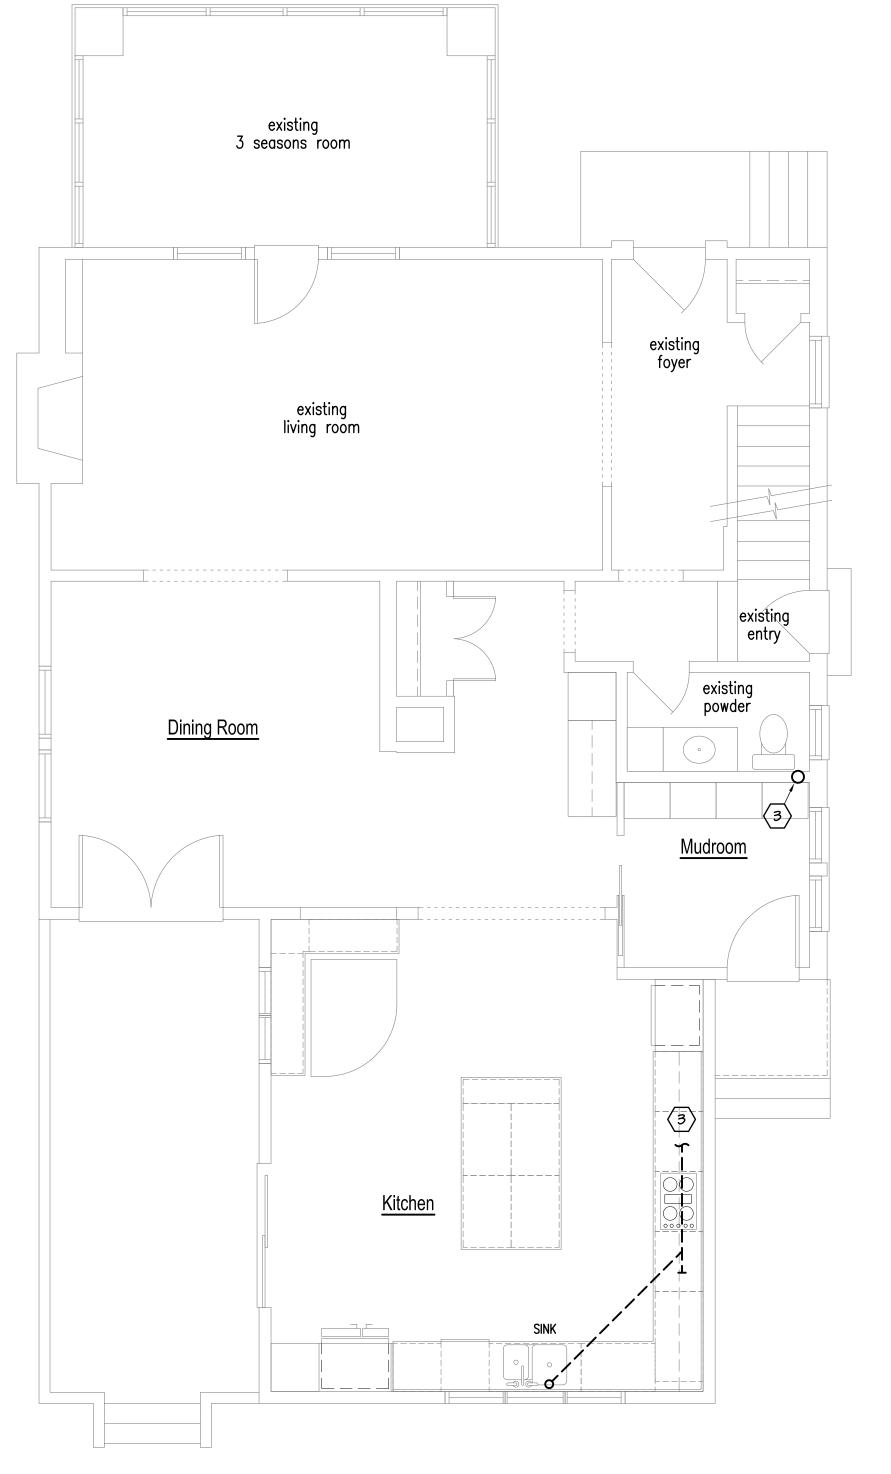


FIRST FLOOR HVAC PLAN

SCALE: 1/4" = 1'-0"

SANITARY STACK DIAGRAM

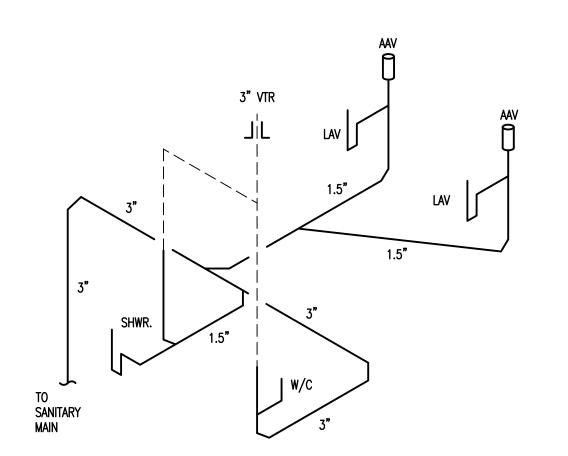

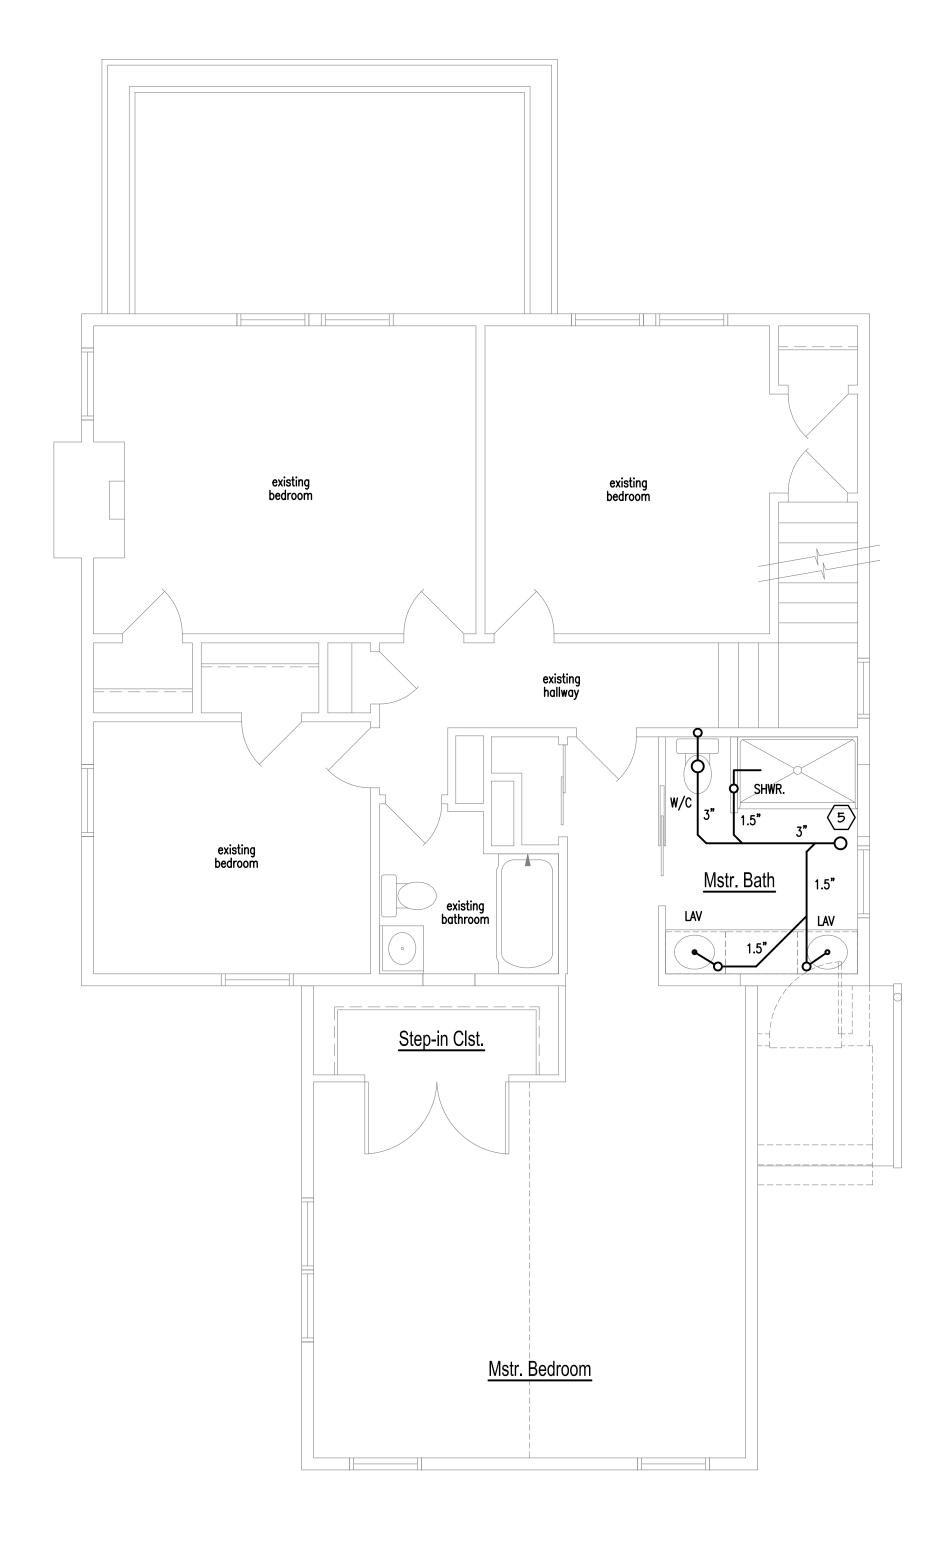

SECOND FLOOR HVAC PLAN

SCALE: 1/4" = 1'-0"

Plan Notes:

- 1. EXISTING SANITARY STACK TO REMAIN.
- 2. EXISTING WATER HEATER TO REMAIN.
- 3. 3" SANITARY STACK DROP FROM FLOOR ABOVE.
- 4. TO EXISTING SANITARY STACK. 5. 3" STANITARY STACK DROP.

GENERAL NOTES

- 1. IF PRINTED SHEET IS LESS THAN 36 IN. WIDE BY 24 IN. HIGH USE GRAPHIC SCALE. 2. FIELD DETERMINE ALL DIMENSIONS WHICH AFFECT ANY NEW CONSTRUCTION PRIOR TO START OF ANY NEW WORK. IMMEDIATELY NOTIFY THE OWNER OR OWNER'S
- DISCREPANCIES HAVE BEEN RESOLVED. 3. ALL PLUMBING SHALL BE INSTALLED IN ACCORDANCE WITH ALL CITY, COUNTY AND STATE CODES AND LAWS (IPC-16) AS THEY APPLY, INCLUDING THE BOARD OF

REPRESENTATIVE OF ANY DISCREPANCIES BETWEEN DRAWINGS AND ACTUAL FIELD CONDITIONS; DO NOT PROCEED WITH THAT PORTION OF THE WORK UNTIL ALL

- 4. UNDERGOUND SANITARY PIPING SHALL BE SCHEDULE 40 PVC PIPE AND FITTINGS
- 5. ABOVE GROUND SANITARY PIPING SHALL BE SCHEDULE 40, PVC PIPING AND FITTINGS EXCEPT IN RETURN AIR PLENUMS WHERE PIPING SHALL BE WRAPPED IN METAL OR PIPING MATERIAL SHALL BE COPPER OR NO-HUB IN ACCORDANCE WITH THE APPLICABLE CODE.
- 6. UNDERGROUND WATER PIPING SHALL BE TYPE K SOFT COPPER INSTALLED WITHOUT FITTING OR COUPLINGS.
- 7. ABOVE GROUND WATER PIPING SHALL BE TYPE L HARD DRAWN COPPER WITH WROUHT
- COPPER FITTINGS. 8. GAS PIPING SHALL BE SCHEDULE 40 BLACK STEEL.
- 9. PROVIDE A COMPLETE AND BALANCED HVAC SYSTEM.

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TAL BENDOR AND NATHAN RENDER 110 S. STANWOOD ROAD COLUMBUS, OHIO 43209

JOB SITE: 110 S. STANWOOD ROAD COLUMBUS, OHIO 43209

JOB NUMBER:

DATE: 05/12/19

1908

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R.L.E. CHECKED:


STAFF SCALE

AS NOTED

REVISIONS:


DRAWING TITLE: PLUMBING PLAN

SHEET NUMBER

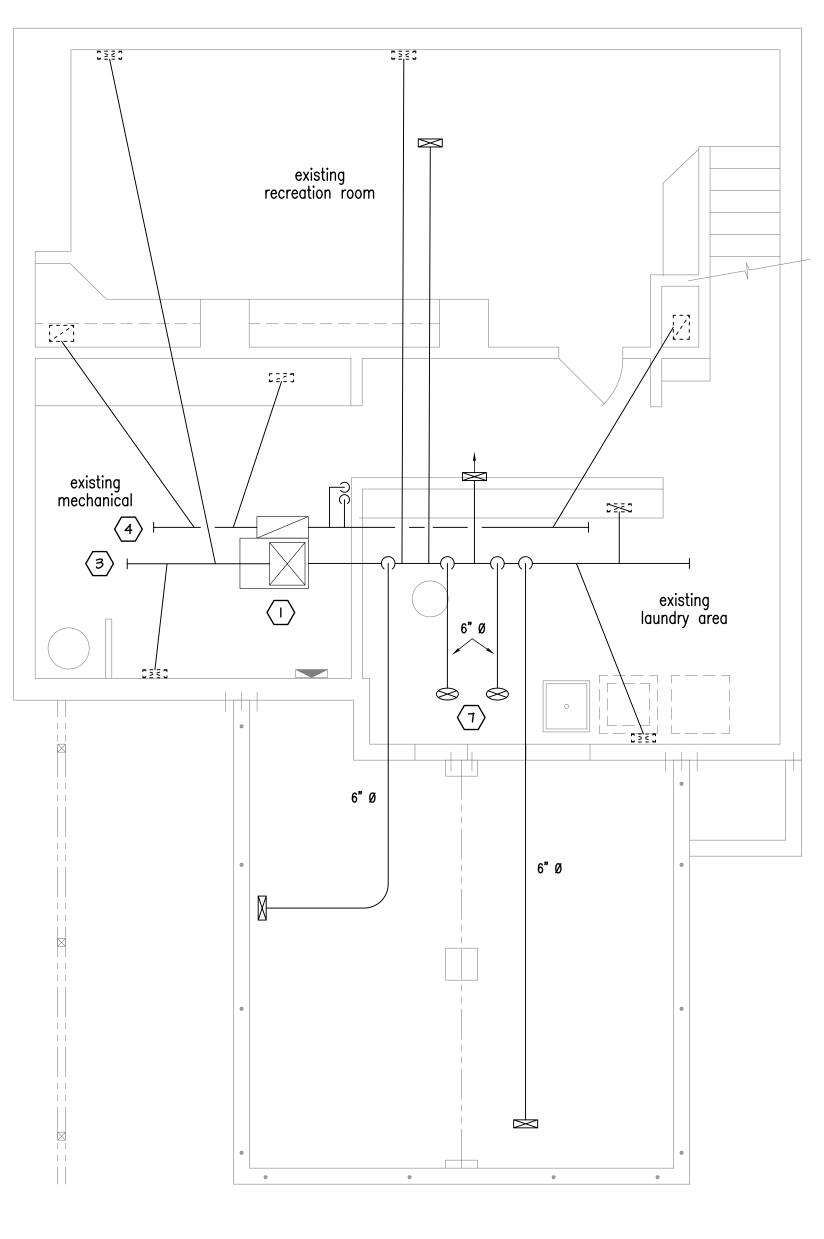


BASEMENT HVAC PLAN

SCALE: 1/4" = 1'-0"

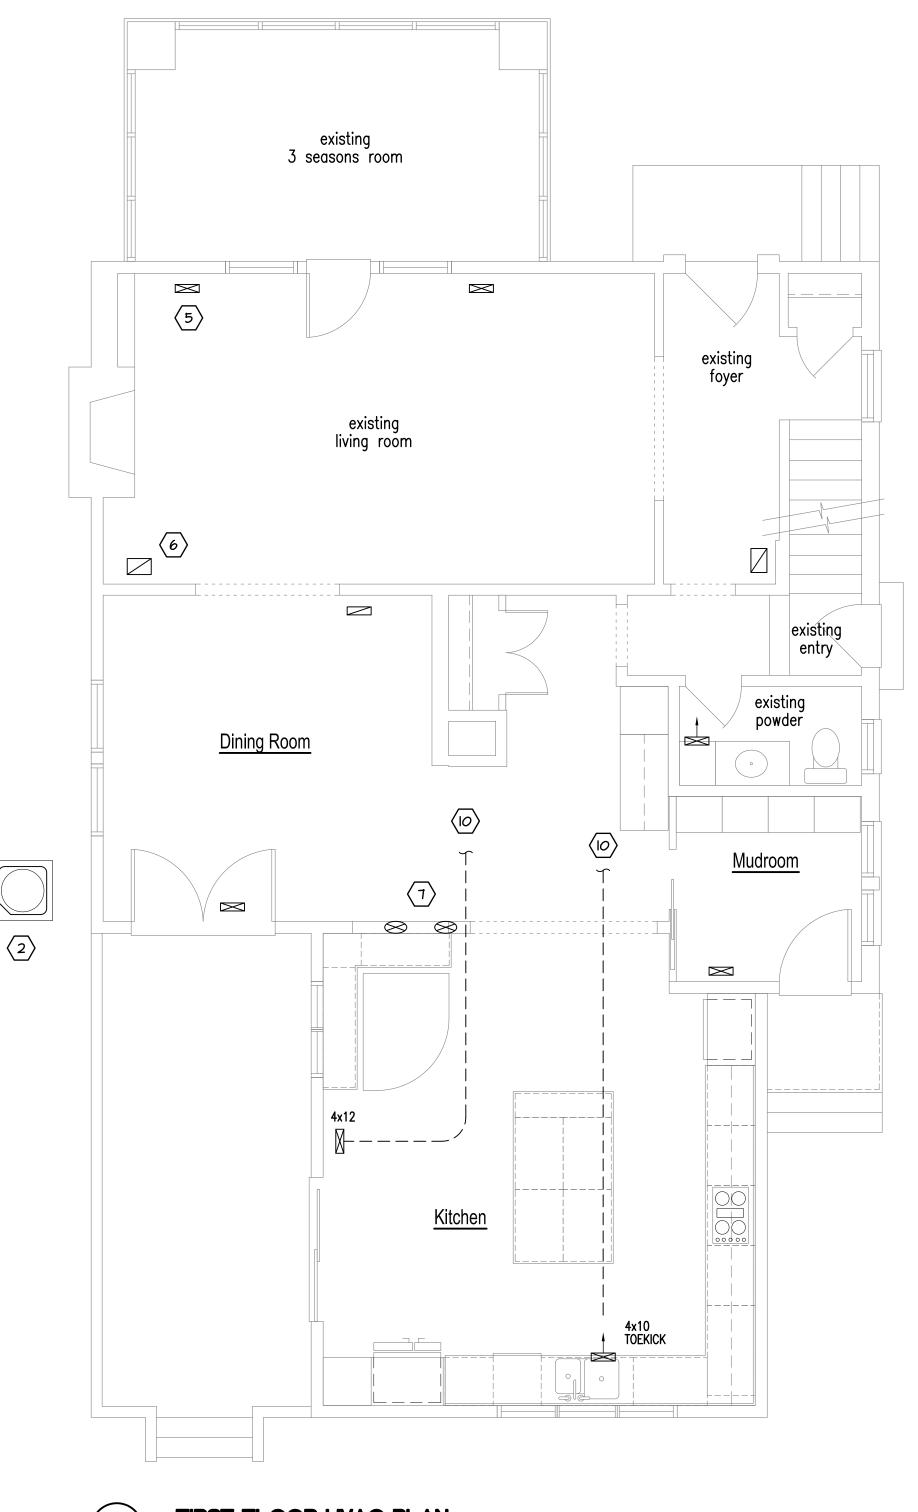

B FIRST FLOOR HVAC PLAN

SCALE: 1/4" = 1'-0"

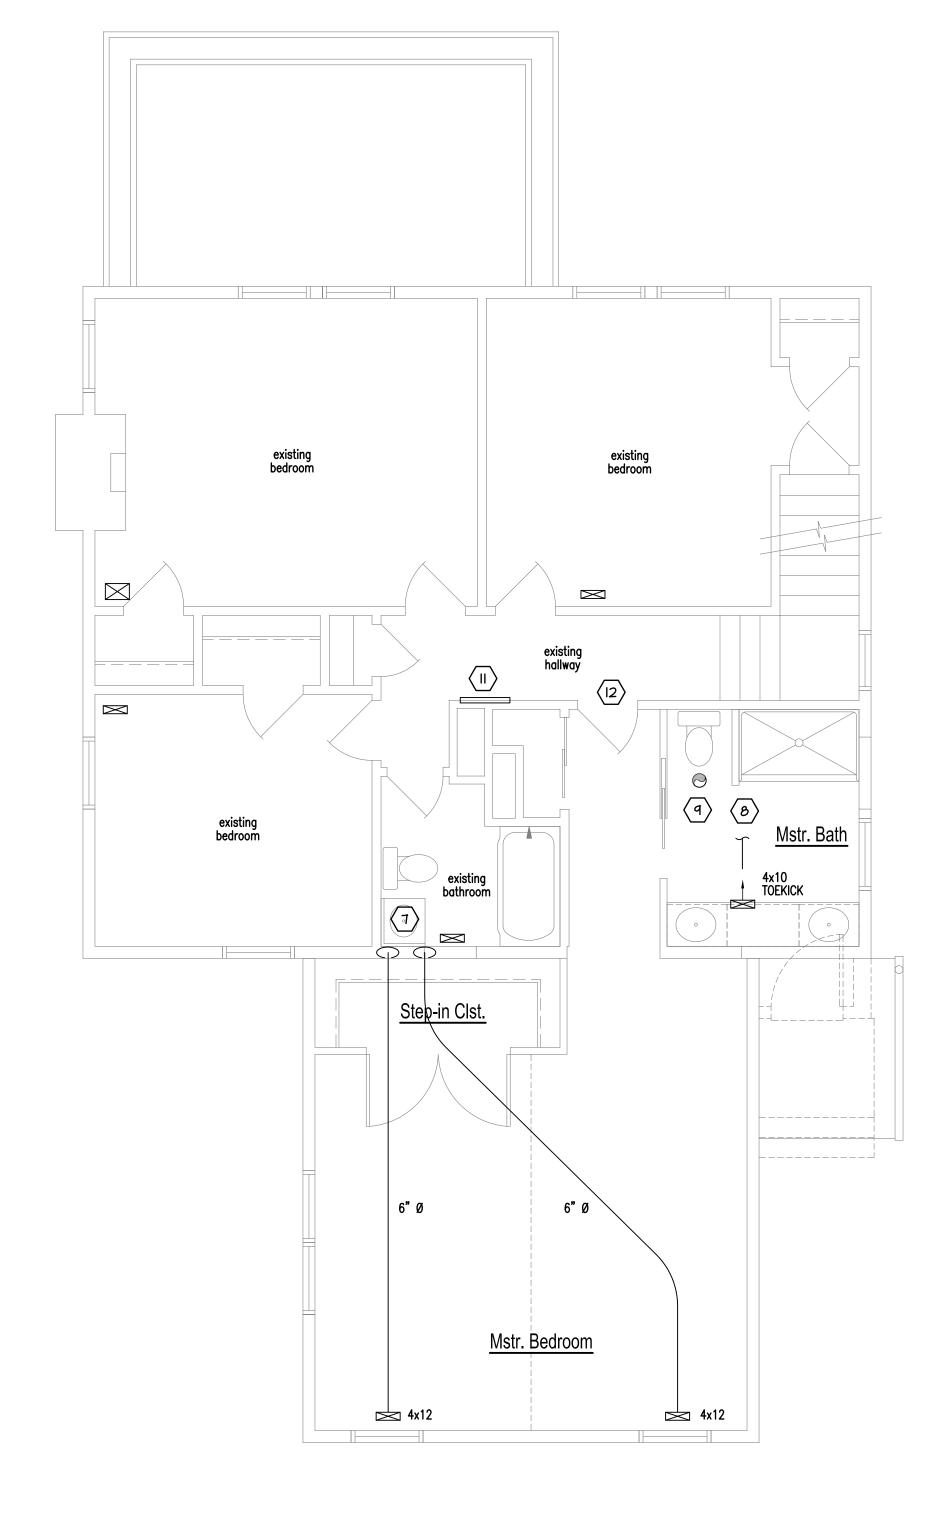



Plan Notes:

- 1. INSTALL NEW FURNACE IN EXISTING LOCATION.
- 2. INSTALL NEW AIR CONDITIONER. LOCATION MAY VARY.
- 3. EXISTING SUPPLY DUCTWORK TO REMAIN, TYPICAL.
- EXISTING RETURN DUCKWORK TO REMAIN, TYPICAL.
 FYISTING SUPPLY AIR DIFFLISER TO REMAIN TYPICAL.
- 5. EXISTING SUPPLY AIR DIFFUSER TO REMAIN, TYPICAL6. EXISTING RETURN AIR GRILLE TO REMAIN, TYPICAL.
- 7. SUPPLY AIR DUCTWORK TO SECON FLOOR.
- 8. INSTALL TOE—KICK SUPPLY AIR DIFFUSER IN VANITY BASE, CONNECT TO EXISTING SUPPLY AIR DUCTWORK.
- 9. INSTALL 75 CFM EXHAUST FAN, VENTED TO EXTERIOR.
- 10. CONNECT TO EXISTING SUPPLY AIR DUCTWORK.
- 11. EXISTING RETURN AIR. TO REMAIN.
- 12. UNDERCUT DOOR 1" TO PROVIDE RETURN AIR.

GENERAL NOTES

- IF PRINTED SHEET IS LESS THAN 36 IN. WIDE BY 24 IN. HIGH USE GRAPHIC SCALE.
 FIELD DETERMINE ALL DIMENSIONS WHICH AFFECT ANY NEW CONSTRUCTION PRIOR TO START OF ANY NEW WORK. IMMEDIATELY NOTIFY THE OWNER OR OWNER'S
- REPRESENTATIVE OF ANY DISCREPANCIES BETWEEN DRAWINGS AND ACTUAL FIELD CONDITIONS; DO NOT PROCEED WITH THAT PORTION OF THE WORK UNTIL ALL DISCREPANCIES HAVE BEEN RESOLVED.
- 3. NEW AND EXISTING SIZES SHOWN ARE INTERIOR DUCT SIZES.
- DUCTWORK AND PIPING LAYOUTS SHOWN ARE SCHEMATICALLY DRAWN, THE EXACT LOCATIONS OF ALL DUCTWORK, PIPING, AIR DEVICES, ETC., SHALL BE DETERMINED BY THE STRUCTURE AND THE WORK OF OTHER TRADES.
 PROVIDE ALL TRANSITIONS, BOOTS, FITTINGS, ETC. AS REQUIRED TO ACHIEVE DUCT/DIFFUSER/REGISTER CONNECTIONS; FIELD VERIFY EXACT REQUIREMENTS PRIOR
- TO STARTING ANY WORK.

 6. FURNISH AND INSTALL WIRES, HANGERS, CLAMPS, AUXILIARY STEEL (SHEETS, BARS, RODS, ETC.), INSERTS, SLEEVES, EXPANSION SHIELDS, AND NECESSARY DEVICES AND COMPONENTS TO SAFELY SUPPORT THE WORK IN ACCORDANCE WITH THE
- MANUFACTURER'S PRINTED INSTALLATION INSTRUCTIONS.

 7. TOILET ROOM EXHAUST FAN(S) TO BE MIN. CFM CAPACITY AS SHOWN; DUCTING OF FAN TO BE CARRIED TO THE EXTERIOR OF BUILDING; PROVIDE ALL BOOTS, JACKS, DAMPERS, SLEEVES AND FLASHING'S AS REQUIRED FOR A COMPLETE WEATHER— TIGHT
- PROVIDE A COMPLETE AND BALANCED HVAC SYSTEM.



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PROJECT

TAL BENDOR AND NATHAN RENDER 110 S. STANWOOD ROAD COLUMBUS, OHIO 43209

JOB SITE: 110 S. STANWOOD ROAD COLUMBUS, OHIO 43209

JOB NUMBER:

DATE: 05/12/19

1908

DRAWN:

R.L.E.

CHECKED:

STAFF
SCALE:


AS NOTED


REVISIONS:

DRAWING TITLE:

HVAC PLAN

SHEET NUMBER

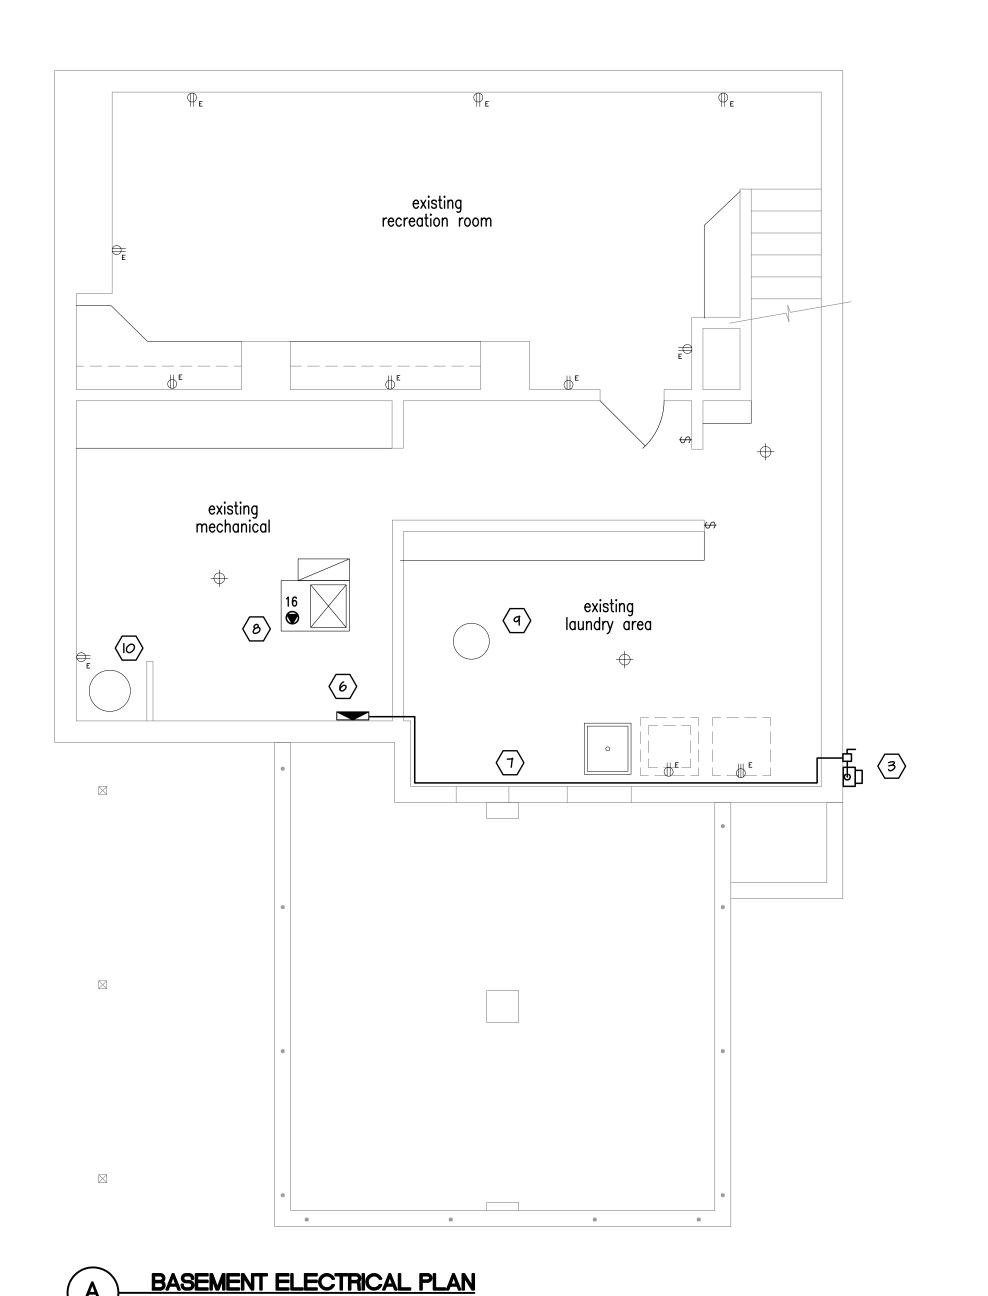

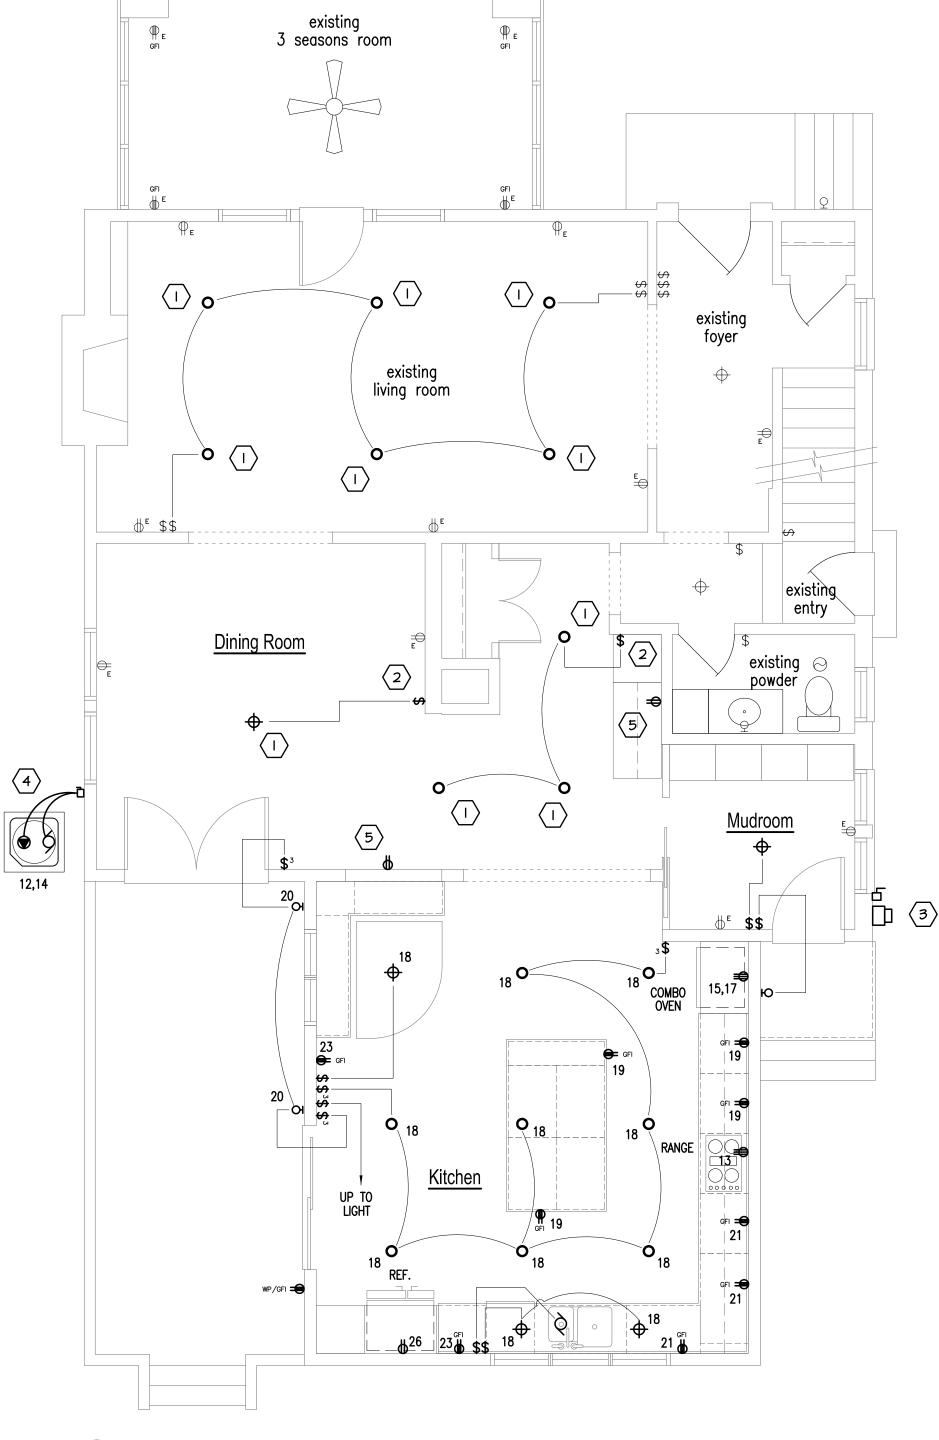


FIRST FLOOR ELECTRICAL PLAN SCALE: 1/4" = 1'-0"

		Э	ele	ctr	ic	pa	ne			
DESIGNATION "A"	МСВ	VOLTAGE 12	20/24	0				1 PHASE 3	3 WIRE	200A MCB
LOAD DESCRIPTION	WIRE	BREAKER	CKT.		Α	В	CKT.	BREAKER	WIRE	LOAD DESCRIPTION
EXIST. LIGHT/RECEPT			1		`		2			EXIST. LIGHT/RECEPT
EXIST. LIGHT/RECEPT			3				4			EXIST. LIGHT/RECEPT
EXIST. LIGHT/RECEPT			5				6			EXIST. LIGHT/RECEPT
EXIST. LIGHT/RECEPT			7				8			EXIST. LIGHT/RECEPT
EXISTING DRYER		40	9				10			EXIST. LIGHT/RECEPT
		40	11				12	30	10	AIR COND.
GAS RANGE	12	20	13				14		10	7 W.C. GOLD.
COMBO OVEN	8	40	15				16	20	12	FURNACE
COMBO OVER	8	70	17				18	20	12	KIT. LIGHTING
KITCHEN RECEPT	12	20	19				20	20	12	EXTERIOR LIGHTING
KITCHEN RECEPT	12	20	21				22	20	12	BEDROOM LIGHTING
KITCHEN RECEPT	12	20	23				24	20	12	BATHROOM LIGHTING
RECEPTACLES	12	20	25				26	20	12	REFRIGERATOR
RECEPTACLES	12	20	27				28			
BATHROOM GFI REC.	12	20	29				30			
EXTERIOR GFI REC.	12	20	31				32			
			33				34			
			35				36			
			37				38			
			39				40			
			41				42			
					· •	1				
						NOTES	:			
) BALANCE NEW CTRICAL PANEL
										ITS NOT TO EXCEED FOR EXISTING PANEL

INSTALL NEW 200A, 42 SPACE MAIN PANEL.

MAINTAIN EXISTING CIRCUITS

ADD NEW CIRCUITS AS SHOWN.

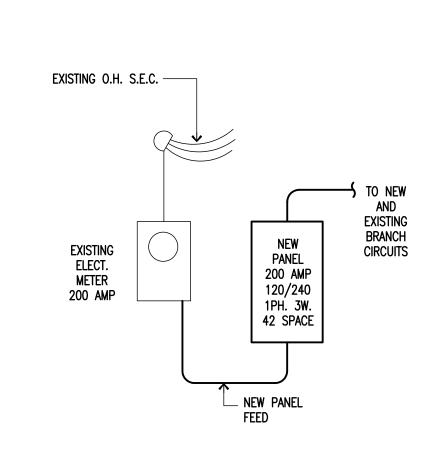

Electric	cal Symbols		
 	CEILING MOUNTED LIGHT FIXTURE.	⊕ WP/GFI	NEW 110v DUPLEX GROUND FAULT CIRCUIT INTERRUPTER RECEPTACLE, WITH WATER PROOF BOX.
Q	WALL MOUNTED LIGHT FIXTURE.	€	NEW 220v RECEPTACLE
0	RECESSED CAN LIGHT FIXTURE.		SPECIAL PURPOSE ELECTRICAAL CONNECTION
Ø	RECESSED EYEBALL CAN LIGHT FIXTURE.	✓ PH	PHONE JACK
n		d Data	DATA PORT
	CEILING FAN/LIGHT FIXTURE.	◀ TV	CATV JACK
Δ	,	Ò	MOTOR
8	SECURITY LIGHT FIXTURE.	ď	DISCONNECT
\$	NEW SINGLE POLE WALL SWITCH (46" M.H.)	Θ	INSTALL NEW EXHAUST FAN.
\$ 3	NEW SINGLE POLE THREE-WAY WALL SWITCH (46" M.H.)		INSTALL NEW EXHAUST FAN/LIGHT.
=	NEW 110v DUPLEX RECEPTACLE	حب	mones hen same same
GFI	NEW 110v DUPLEX GROUND FAULT CIRCUIT INTERRUPTER RECEPTACLE	S	SMOKE DETECTOR

bedroom Step-in Clst. Mstr. Bedroom DOWN TO SWITCH

SECOND FLOOR ELECTRICAL PLAN SCALE: 1/4" = 1'-0"

Plan Notes:

- 1. INSTALL NEW LIGHT FIXTURE MAINTAIN EXISTING CIRCUIT.
- 2. INSTALL NEW SINGLE POLE SWITCH AT NE LOCATION AS SHOWN.
- 3. RE-LOCATE EXISTING METER CENTER AND DISCONNECT AS SHOWN. COORDINATE WITH THE LOCAL ELECTRIC SERVICE PROVIDER.
- 4. INSTALL NEW AIR CONDITIONER AND DISCONNECT, LOCATION MAY VARY.
- 5. INSTALL NEW CONVENIENCE OUTLET ON EXISTING CIRCUIT IN LOCATION AS SHOWN.
- 6. INSTALL NEW 200A., 42 SP., 120/240V. ELECTRIC PANEL.
- 7. PROVIDE NEW SERVICE ENTRANCE CABLE IN 2" CONDUIT TO NEW ELECTRIC PANEL. COORDINATE WIRE SIZE WILL LOCAL ELECTRIC SERVICE PROVIDER.
- 8. WIRE NEW FURNACE IN EXISTING LOCATION.
- 9. EXISTING WATER HEATER MAINTAIN EXISTING CIRCUIT.
- 10. EXISTING SUMP PUMP, MAINTAIN EXISTING CIRCUIT.

Electrical Notes:

- 1. ALL EQUIPMENT SHALL BEAR THE U.L. LABEL AND BE INSTALLED ACCORDING TO THE LATEST EDITION OF THE NEC.
- 2. ALL NEW WIRE SHALL BE COPPER UNLESS OTHERWISE NOTED ON THE DRAWINGS. WIRES SHALL BE SIZED ACCORDING TO NEC ARTICLE 310-15.
- 3. ALL NEW WIRING SHALL BE INSTALLED ROMEX SIZED ACCORDING TO NEC CHAPTER 9, TABLE 1. NON-METALLIC CONDUIT SHALL BE ACCEPTABLE BELOW GRADE OR IN SLAB.
- MC CABLE IS ACCEPTABLE IN CONCEALED LOCATIONS.
- 4. ALL NEWLY INSTALLED OUTLET, SWITCH AND JUNCTION BOXES SHALL COMPLY WITH NEC ARTICLE 370 AND BE SIZED ACCORDING TO TABLE 370-6(a).
- 5. ALL NEW SPLICES SHALL BE MADE ONLY AT ACCEPTABLE LOCATIONS, OUTLET BOXES, PANEL BOARDS, JUNCTION BOXES, ETC. TERMINAL CONNECTIONS AND SPLICES IN ALL WIRE #6 AND LARGER SHALL BE MADE WITH APPROVED SOLDERLESS CONNECTORS, PROPERLY INSULATED AND TAPED WHERE NECESSARY. IN SMALLER WIRES ALL SPICES SHALL BE MADE EITHER WITH APPROVED SOLDERLESS CONNECTORS OR SHALL BE SOLDERED AND TAPED AS REQUIRED TO INSURE PROPER INSULATION.
- 6. ELECTRICAL WIRING, EQUIPMENT AND INSTALLATION SHALL CONFORM TO THE REQUIREMENTS OF THE LOCAL CODE AGENCIES. NFPA STANDARD NO. 70 AND THE LATEST EDITION OF THE NATIONAL ELECTRICAL CODE (NEC).
- 7. INSTALL ALL ELECTRICAL APPLIANCES PER MANUFACTURERS DATA & VERY EXACT REQUIREMENTS.
- 8. ALL OUTLETS WITHIN SIX FEET OF KITCHEN SINK, BATHROOM SINK AND GARAGE
- LOCATIONS ARE TO BE G.F.C.I. 9. ALL NEW SMOKE DETECTORS TO BE INTERCONNECTED w/ 110v AND BATTERY BACKUP.
- 10. ALL RECEPTACLES IN BEDROOM SHALL BE PROTECTED WITH ARC FAULT CIRCUIT BREAKERS AT THE MAIN PANEL BOX.
- 11. COMBINATION-TYPE AFCI-PROTECTIVE DEVICES ARE REQUIRED IN ALL DWELLING UNITS, EXCEPT KITCHENS, BATHROOMS GARAGES AND BASEMENTS PER NEC 210.12(A).

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PROJECT

TAL BENDOR AND NATHAN RENDER 110 S. STANWOOD ROAD COLUMBUS, OHIO 43209

JOB SITE: 110 S. STANWOOD ROAD COLUMBUS, OHIO 43209

JOB NUMBER:

DATE: 05/12/19

1908

DRAWN:

R.L.E.

CHECKED: STAFF

SCALE: AS NOTED

REVISIONS:

DRAWING TITLE:

ELECTRICAL PLAN

SHEET NUMBER

CUSTOMER INFORMATION:

PLOT PLAN FOR: TALBENDOR & NATHAN RENDER

110 S. STANWOOD ROAD COLUMBUS, OH 43209


PROJECT INFORMATION:

ADDRESS: 110 S. STANWOOD ROAD COLUMBUS, OH 43209 LOT NUMBER: 382

SUB DIV.: ARDMORE #2 ZONED: R

PARCEL No.: 020-000974-00

S. Stanwood Road

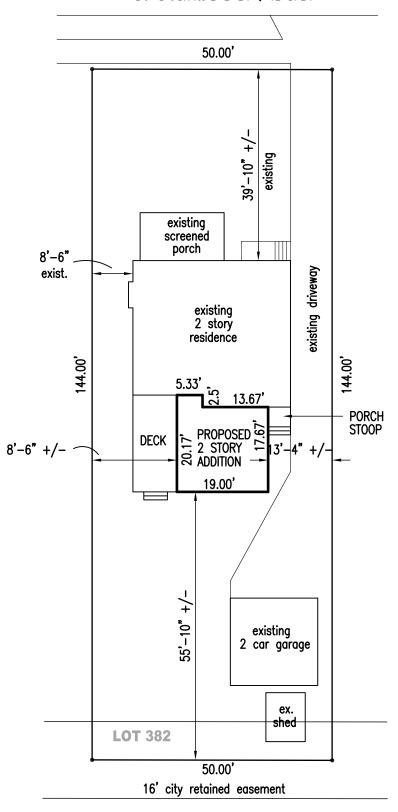

110 S. Stanwood Rd. - Front (West)



110 S. Stanwood Rd. - Back (East)



110 S. Stanwood Rd. - Side (South)



110 S. Stanwood Rd. - Side (North)

