

#### **CITY OF BEXLEY**

#### ARCHITECTURAL REVIEW BOARD

#### **AGENDA**

DATE: March 12, 2020

TIME: 6:00 P.M.

PLACE: City Council Chambers, Bexley Municipal Building

1. Call to Order

2. Roll Call

- 3. Approval of Minutes from the February 13th, 2020, ARB meeting.
- 4. Public Comment:

#### 5. **NEW BUSINESS**:

A. Application No.: ARB 20-06

Applicant: Amy Lauerhass
Owner: Brian & Richard Ey

Location: 2468 Elm

**ARB Request**: The applicant is seeking architectural review and approval to allow an addition and a covered porch at the rear of the existing principal structure.

B. Application No.: ARB 20-08

Applicant: Amy Lauerhass

Owner: Mary & Andrew Auch Location: 31 Bullitt Park Pl

**ARB Request**: The applicant is seeking architectural review and approval to allow a 2<sup>nd</sup> floor addition at the rear of the principal structure, and new covered porch additions at the front and rear of the principal structure.

C. Application No.: ARB-20-07

Applicant: David Pryor

Owner: Pryor Development LLC

Location: 752 Vernon Rd.

**ARB Request**: The applicant is seeking architectural review and approval to

allow an addition to the rear of the existing principal structure.

D. Application No.: BZAP-20-3 Applicant: Genevieve Brune Owner: Genevieve Brune Location: 2700 Sherwood

**ARB Request**: The applicant is seeking architectural review and a recommendation to the Board of Zoning and Planning, to allow a 676square foot detached garage that is 22'9" in height, to be constructed in the rear yard.

E. Application No.: BZAP-20-04 Applicant: Pete Foster

Owner: 75Shuffle LLC Location: 633 Euclaire Ave.

ARB Request: The applicant is seeking architectural review and a

recommendation to the Board of Zoning and Planning, to allow an addition to the rear of

the principal structure, which includes an attached garage.

F. Application No.: BZAP-20-5 Applicant: Brian Jones

Owner: Jeffrey & Jennifer McCCloskey

Location: 209 S. Columbia Ave.

**ARB Request:** The applicant is seeking architectural review and a recommendation to the Board of Zoning and Planning, to allow an addition to the rear of the principal structure, which would attach and enclose the existing detached garage and add a

detached garage.

G. Application No.: BZAP-20-6

Applicant: Brian Marzich

Owner: Laura Maddox & Kevin Keenan

Location: 796 S. Remington

**ARB Request**: The applicant is seeking architectural review and a

recommendation to the Board of Zoning and Planning, to allow a 2-story addition to the

rear of the 2-story principal structure.



# PUBLIC NOTICE CITY OF BEXLEY ARCHITECTURAL REVIEW BOARD

The Bexley Architectural Review Board (ARB) will hold a Public Meeting on the following case on <u>Thursday, March 12, 2020 at 6:00 PM</u>, in City Council Chambers, Bexley City Hall, 2242 East Main Street, Bexley, Ohio.

The APPLICANT or REPRESENTATIVE must be present at the Public Hearing. The Board may dismiss, without hearing, an application if the applicant or authorized representative is not in attendance. The Board may move to consider the application in those circumstances where dismissal without hearing would constitute a hardship on the adjoining property owners or other interested persons.

a. Application No.: ARB-20-6

Applicant: Amy Lauerhass
Owner: Briana & Richard Ey

Location: 2468 Elm Ave.

**ARB Request**: The applicant is seeking architectural review and approval to allow an addition and covered porch addition to the rear of the existing

principal structure.

A copy of this application is available for review in the Building Department office during the hours of 8:00 A.M. until 4:00 P.M. If you have any questions, please call the Bexley Building Department at 559-4240.

Mailed by: 02-27-2020

\*(ARB) Architectural Review Board
Application - Major Review (for
Additions to Principal and Accessory
structures and New Principal
Structures that DO NOT REQUIRE A
VARIANCE. (You must proceed to the
BZAP application if you wish to
request a variance from the Zoning
Code) ARB meets on the 2nd
Thursday of the month (except
December) applications are due 4
weeks prior.

#### **Applicant**

Ω

Amy Lauerhass 614-371-3523

@ amy@lauerhassarchitecture.com

#### Location

2468 ELM AV Bexley, OH 43209

### **ARB-20-6**

Status: Active

Submitted: Feb 12, 2020

#### A.1: Project Information

Brief Project Description - ALSO PROVIDE 2 HARD COPIES (INCLUDING PLANS) TO THE BUILDING DEPARTMENT..

One story addition and covered porch addition to the rear of the home.

Architecture Review Demolition

true -

Planned Unit Dev Rezoning

•

#### A.1: Attorney / Agent Information

Agent Name Agent Address

-

Agent Email Agent Phone

--

Property Owner Name Property Owner phone

<del>--</del>

If owner will not be present for review meeting, you must submit a permission to represent signed by the current owner.

#### A.2: Fee Worksheet

Estimated Valuation of Project Minor Architectural Review

140000

Major Architectural Review Variance Review - Fill out a BZAP Application instead.

true --

Zoning Review Type

<del>--</del>

Sign Review and Architectural Review for Commercial Projects

**Review Type** 

Appeal of ARB decision to BZAP

Appeal of BZAP decision to City Council

#### **B: Project Worksheet: Property Information**

**Occupancy Type Zoning District** 

Residential R-6

**Use Classification** 

R-6 (35% Building and 60% Overall)

#### **B: Project Worksheet: Lot Info**

Width (ft) Depth (ft) 50 121.7

Total Area (SF)

6085

#### **B: Project Worksheet: Primary Structure Info**

**Existing Footprint (SF) Proposed Addition (SF)** 

1114 243

Removing (SF) Type of Structure

One Story Addition

Proposed New Primary Structure or Residence (SF) **Total Square Footage** 

1357

#### B: Project Worksheet: Garage and/or Accessory Structure Info (Incl. Decks, Pergolas, Etc)

**Proposed Addition (SF) Existing Footprint (SF)** 

380

**New Structure Type Ridge Height** 

**Proposed New Structure (SF)** Is there a 2nd Floor

Total building lot coverage (SF) Total of all garage and accessory structures (SF)

380 1737

Total building lot coverage (% of lot) Is this replacing an existing garage and/or accessory structure?

28.5

**B: Project Worksheet: Hardscape** 

**Existing Driveway (SF)** 

1200

**Existing Private Sidewalk (SF)** 

91

Total Hardscape (SF)

1436

**Existing Patio (SF)** 

--

Proposed Additional Hardscape (SF)

145

**B: Project Worksheet: Total Coverage** 

Total overall lot coverage (SF)

3173

Total overall lot coverage (% of lot)

52

C.1 Architectural Review Worksheet: Roofing

Roofing

true

**Existing Roof Type** 

Arch. Dimensional Shingles

**New Single Manufacturer** 

TBD

Structure

House or Principal Structure

**New Roof Type** 

Metal

**New Roof Style and Color** 

Standing Seam Metal; Color TBD

**C.1 Architectural Review Worksheet: Windows** 

Windows

true

**Existing Window Type** 

Double Hung

Other existing window materials

Vinyl

New Window Style/Mat./Color

Double hung + casement/vinyl/white

Structure

House or Principal Structure

**Existing Window Materials** 

Other

**New Window Manufacturer** 

To Match Existing

C.1 Architectural Review Worksheet: Doors

**Doors** 

true

Structure

House or Principal Structure

**Existing Garage Door Type** 

**Existing Entrance Door Type** 

Wood

--

Door Finish

**Proposed Door Type** 

Painted

Fiberglass

**Proposed Door Style** 

French

**Proposed Door Color** 

White

#### C.1 Architectural Review Worksheet: Exterior Trim

**Exterior Trim** 

true

**Proposed New Door Trim** 

Vinyl

**Proposed New Window Trim** 

Vinyl

Do the proposed changes affect the overhangs?

No

**Existing Door Trim** 

Vinyl

**Existing Window Trim** 

Vinyl

Trim Color(s)

White to Match Existing

#### C.2 Architectural Review Worksheet: Exterior Wall Finishes

**Exterior Wall Finishes** 

true

**Existing Finishes Manufacturer, Style, Color** 

Wood Shake Siding; Random Width; Staggered Bottom Edge

Proposed Finishes Manufacturer, Style, Color

Wood Shake Siding; Random Width; Staggered Bottom Edge to

Match Existing

**Existing Finishes** 

Wood Siding

**Proposed Finishes** 

Wood Siding

#### D: (Staff Only) Tree & Public Gardens Commission Worksheet

Design plan with elevations (electronic copy as specified in

instructions plus 1 hard copy)

Applicant has been advised that Landscape Designer/Architect must be present at meeting

Design Specifications as required in item 3 in "Review Guidelines and List of Criteria" above

#### Attachments (8)



Photographs (required) Feb 12, 2020



IMG\_5851.JPG Feb 12, 2020



IMG\_5852.JPG Feb 12, 2020



IMG\_5858.JPG Feb 12, 2020

pdf Architectural Plans which include Exterior Elevations and floor plans of existing and proposed

Feb 12, 2020

pdf Site Plan

Feb 12, 2020

pdf Permission for Agent to represent owner.

Feb 12, 2020

pdf 2020 03 12 - 2468 Elm ARB addition.pdf

Mar 04, 2020

#### **Timeline**

Payment

Status: Paid February 12th 2020, 11:03 am

Zoning Officer

Status: Completed March 5th 2020, 12:32 pm


Assignee: Kathy Rose

Kathy Rose March 5th 2020, 12:32:14 pm

Design Planning Consultant
Status: In Progress
Assignee: Karen Bokor
Architectural Review Board
Status: In Progress
Board of Zoning and Planning
Status: In Progress
- u
City Council
Status: In Progress
Tree Commission
Status: In Progress
Arborist
Status: In Progress

## **ADDITION & RENOVATION FOR:** THE EY RESIDENCE

2468 ELM AVENUE

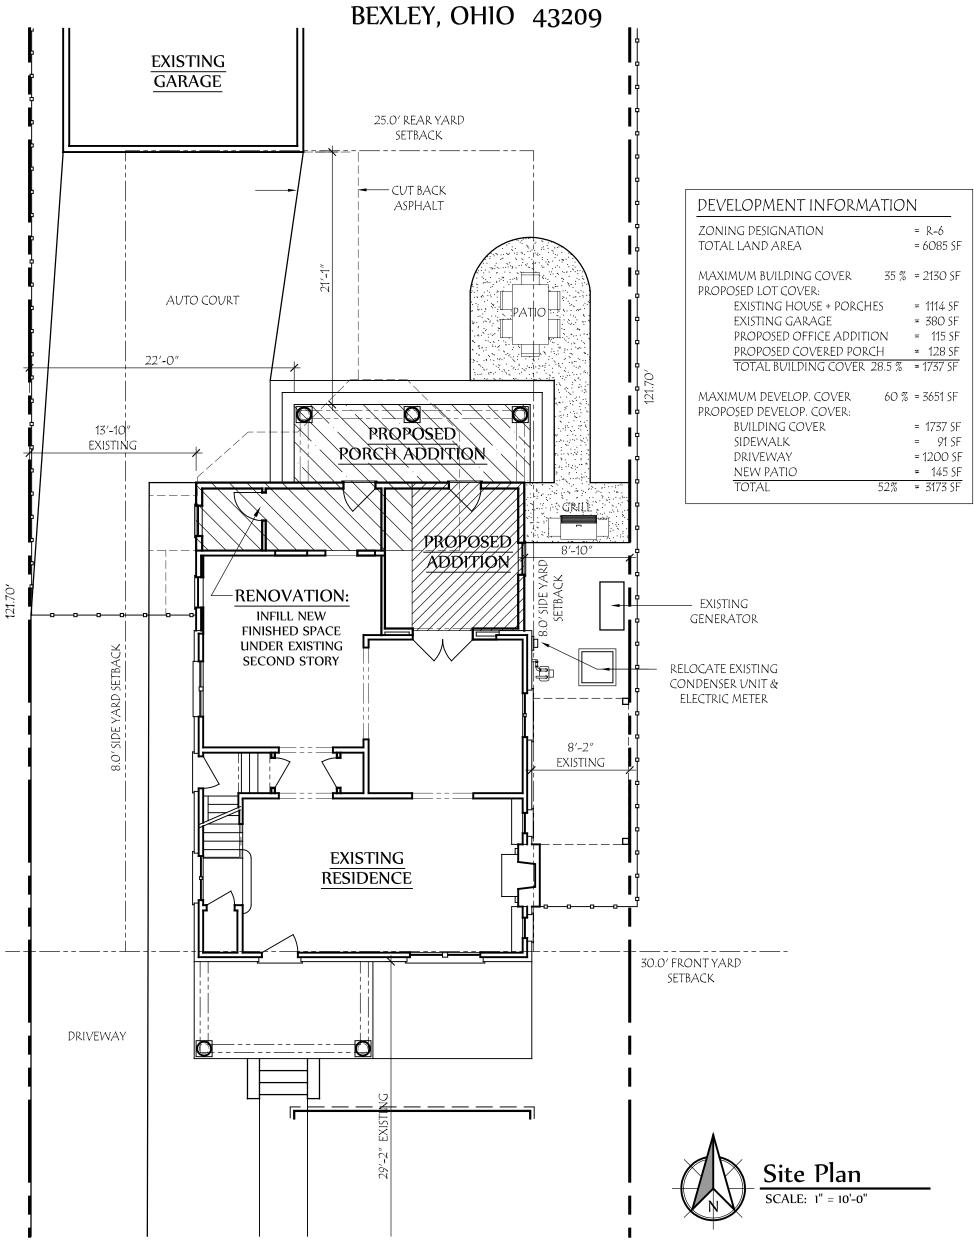




753 Francis Ave. Bexley, OH 43209

		EXISTING FIRST FLOOR EXISTING SECOND FLOOR TOTAL: MAIN RESIDENCE	= 860 SF = 1000 SF = 1860 SF
tecture		PROPOSED FIRST FLOOR	≈ 215 SF
NEW HOME		TOTAL FINISHED RESIDENCE	= 2075 SF
614-371-3523	L		

SQUARE FOOTAGE

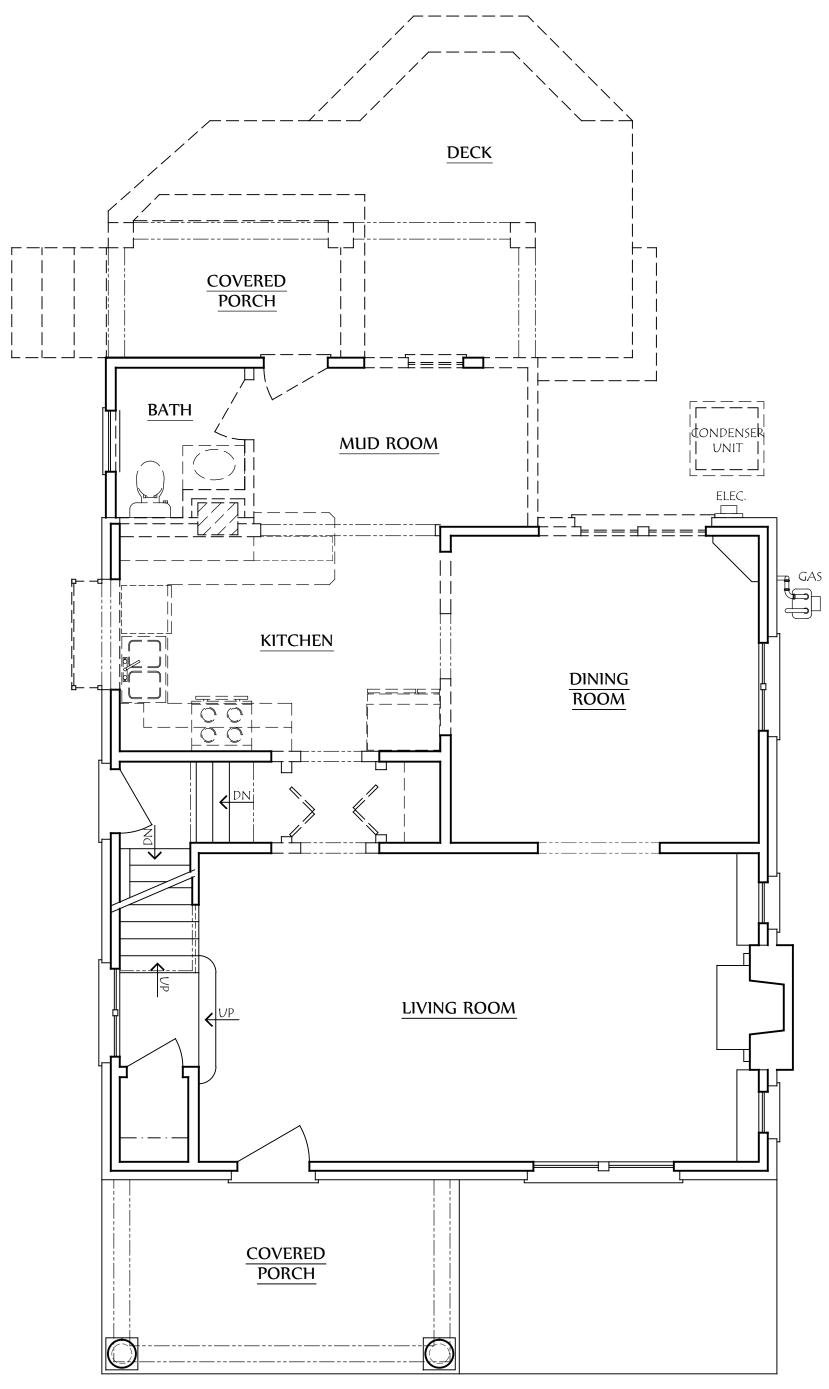

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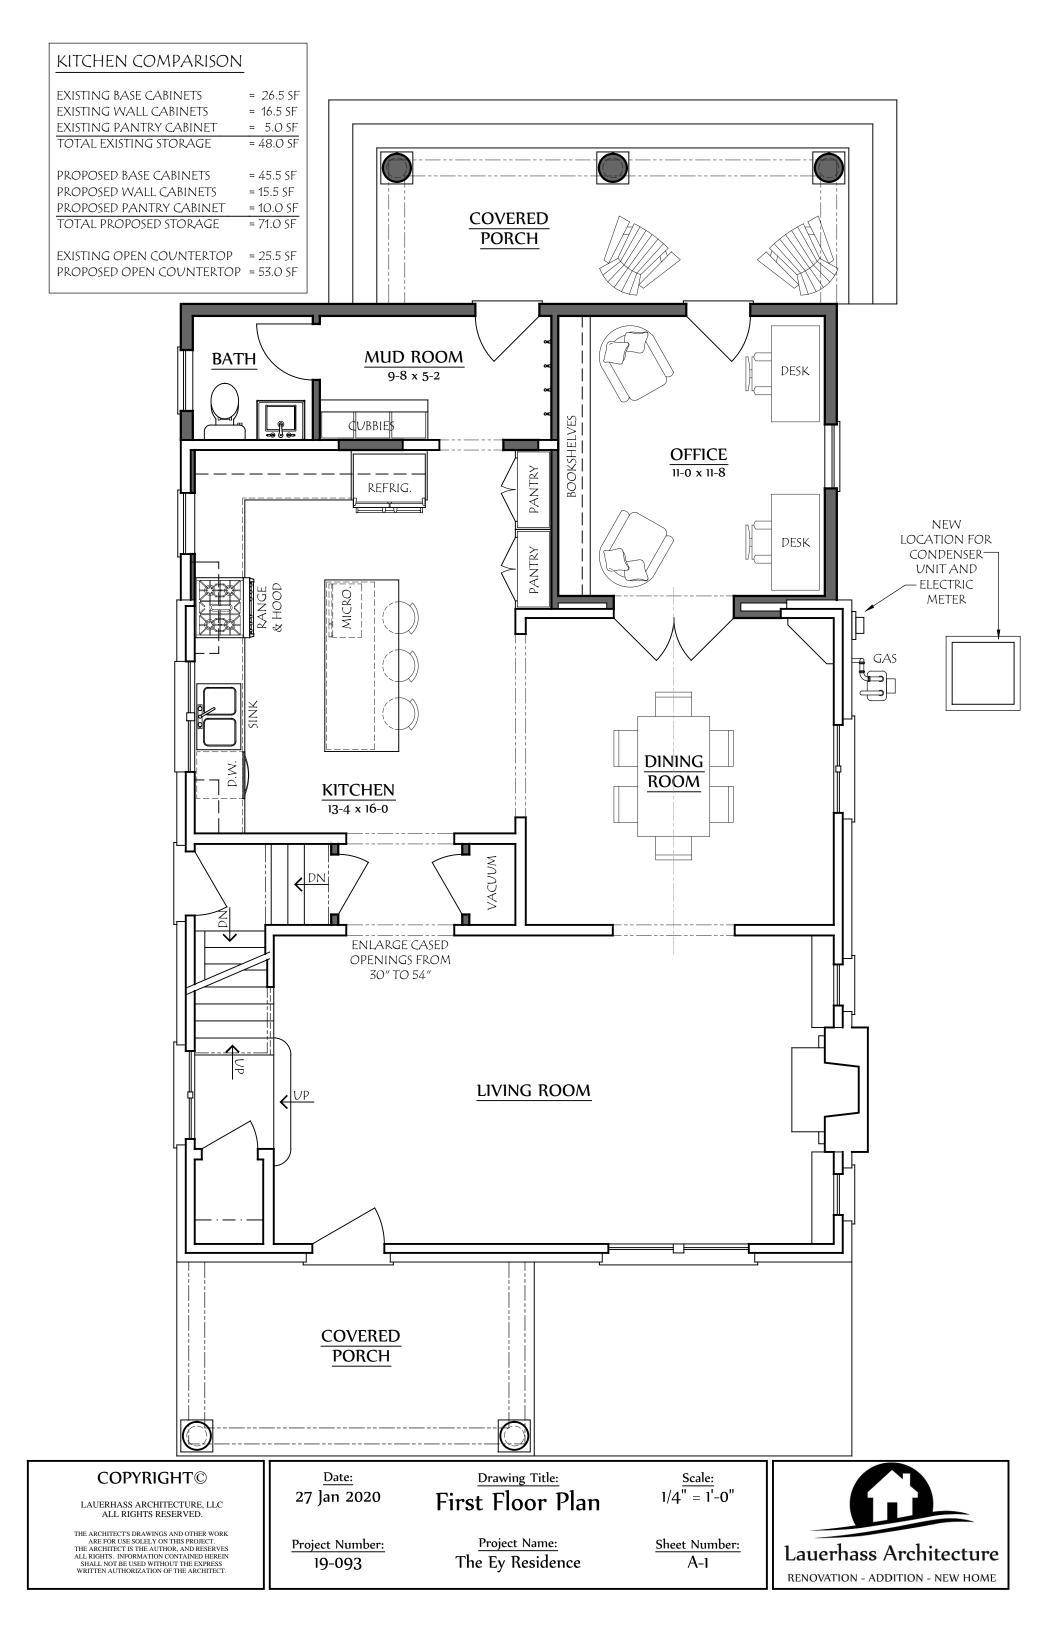
  $\frac{\text{Scale:}}{1/4'' = 1'-0''}$ 

Project Number: 19-093

Project Name:
The Ey Residence

 $\frac{\text{Sheet Number:}}{D\text{-}1}$ 







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<u>Date:</u> 23 Jan 2020 Drawing Title:
Rear Elevation


Scale: 3/16" = 1'-0"

Project Number: 19-093

Project Name:
The Ey Residence

Sheet Number: A-2



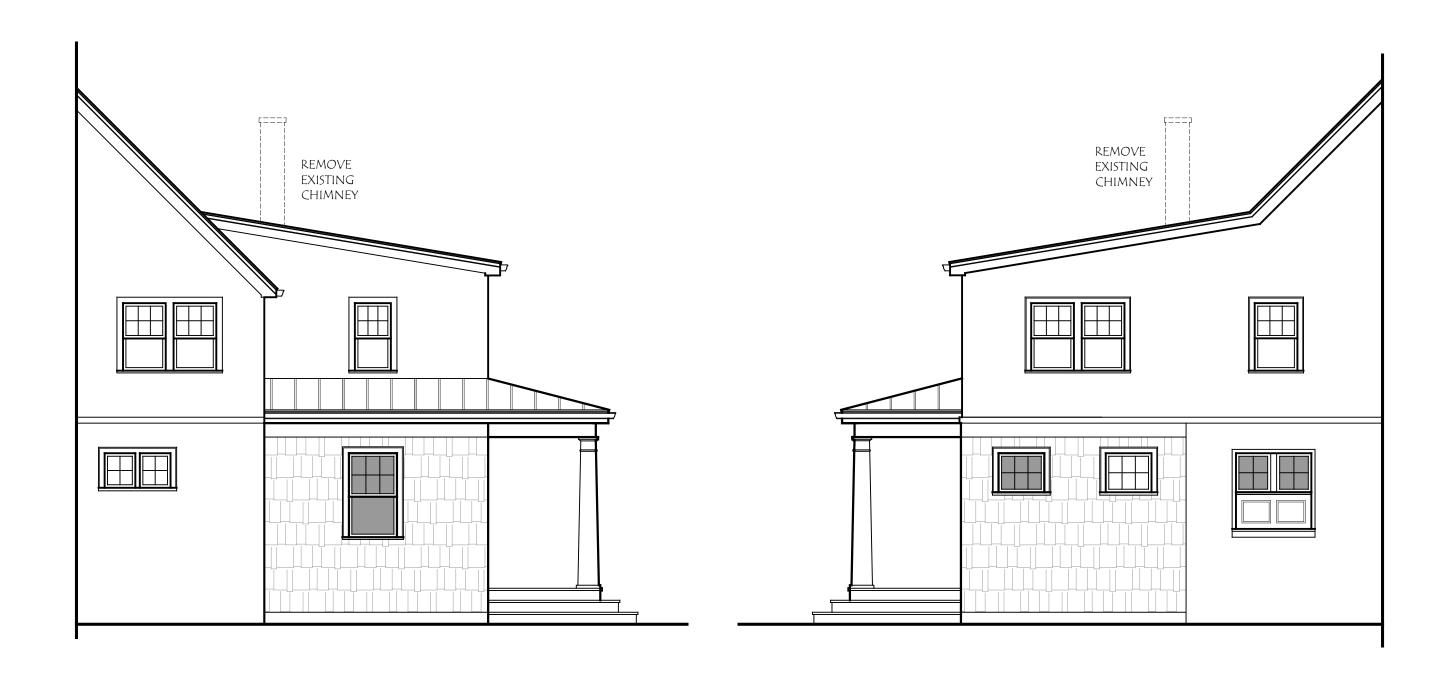

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a. Application No.: ARB-20-8

Applicant: Amy Lauerhass

Owner: Mary & Andrew Auch

Location: 31 Bullitt Park Pl.

**ARB Request**: The applicant is seeking architectural review and approval to allow a 2<sup>nd</sup> floor addition at the rear of the principal structure, and new covered porch additions at the front and rear of the principal structure.

A copy of this application is available for review in the Building Department office during the hours of 8:00 A.M. until 4:00 P.M. If you have any questions, please call the Bexley Building Department at 559-4240.

Mailed by: 02-27-2020

## 5.0' EASEMENT **EXISTING GARAGE** 25.0' REAR YARD SETBACK RELOCATED MAGNOLIA TO LOCATION SELECTED BY — LINE OF existing owner — DRIVEWAY FUTURE PATIO AND STAIRS BY OTHERS -LINE OF NEW DRIVEWAY — PROPOSED NEW REAR ENTRY PORCH PROPOSED SECOND FLOOR ADDITION OVER EXISTING ONE-STORY SECTION 12′-3″ **EXISTING RESIDENCE** PLATTED 30.0' FRONT YARD SETBACK \_\_\_\_\_\_ \_\_\_ \_ \_ \_ \_ \_ \_ \_ \_ \_ \_ \_ \_ 22'-4" AVERAGE **EXISTING FRONT** YARD SETBACK SIDEWALK DRIVEWAY SIDEWALK **BULLITT PARK PLACE**

# ADDITION & RENOVATION FOR: ANDY & MARY AUCH 31 BULLITT PARK PLACE BEXLEY, OHIO 43209

#### GENERAL SPECIFICATIONS: 2013 RESIDENTIAL CODE OF OHIO

INDEX TO DRAWINGS

GENERAL SPECIFICATIONS

D-1 FIRST FLOOR DEMOLITION PLAN

THIRD FLOOR/ROOF PLAN

SECOND FLOOR DEMOLITION PLAN

SITE PLAN

A-1 FOUNDATION PLAN

A-2 SECOND FLOOR PLAN

A-3 EXTERIOR ELEVATIONS

A-4 TYPICAL WALL SECTIONS

E-1 FIRST FLOOR ELECTRICAL PLAN

DEVELOPMENT INFORMATION

ZONING DESIGNATION

PROPOSED LOT COVER:

MAXIMUM BUILDING COVER

EXISTING HOUSE

EXISTING GARAGE

DDODOSED DODOLLE

MAXIMUM DEVELOP. COVER

BUILDING COVER

PROPOSED DEVELOP. COVER:

PATIO + WALK

DRIVEWAY

TOTAL BLDG. COVER

BEXLEY ARB APPLICATION #17-043 A

APPROVAL GRANTED: SEPTEMBER 14, 2017

TOTAL LAND AREA

SECOND FLOOR ELECTRICAL PLAN

= R - 6

35% = 2562 SF

60% = 4392 SF

= 7320 SF

= 1215 SF

= 375 SF

= 71 CF

= 1661 SF

= 890 SF

= 486 SF

FIRST FLOOR PLAN

COVER SHEET

ALL WORK, INCLUDING PLUMBING, HVAC AND ELECTRICAL WORK NOT DETAILED HEREIN, SHALL COMPLY WITH APPLICABLE STATE AND LOCAL BUILDING CODES AND THE BUILDING STANDARDS REFERENCED THEREIN.

ALL WORK SHALL CONFORM TO THE HIGHEST LEVELS OF THE APPROPRIATE INDUSTRY STANDARDS FOR CUSTOM WORK.

ALL WORK TO BE COORDINATED AND SCHEDULED BY THE GENERAL CONTRACTOR.

ALL ITEMS SPECIFIED HEREIN ARE ASSUMED TO BE "OR EQUAL". SUBMIT PRODUCT LITERATURE OR MATERIAL SAMPLES OF ALL PROPOSED SUBSTITUTIONS TO OWNER AND ARCHITECT FOR APPROVAL PRIOR TO ORDERING MATERIAL.

PLAN DIMENSIONS ARE TO THE FACE OF ROUGH FRAMING OR MASONRY UNLESS NOTED OTHERWISE. DIMENSIONS OF EXTERIOR FRAME WALLS INCLUDE 1/2" SHEATHING.

THE STRUCTURE IS DESIGNED TO BE SELF-SUPPORTING AND STABLE AFTER THE BUILDING IS FULLY COMPLETE. IT IS SOLELY THE CONTRACTORS RESPONSIBILITY TO ENSURE THE SAFETY OF THE BUILDING AND ITS COMPONENT PARTS DURING ERECTION. THIS INCLUDES THE ADDITION OF TEMPORARY BRACING THAT MIGHT BE NECESSARY.

IT IS SOLELY THE CONTRACTOR'S RESPONSIBILITY TO FOLLOW ALL APPLICABLE SAFETY CODES AND REGULATIONS DURING ALL PHASES OF CONSTRUCTION.

### SITE CONSTRUCTION

BY LAW, CONTRACTOR OR EXCAVATOR MUST CONTACT THE OHIO UTILITIES PROTECTION SERVICE, 1-800-362-2764 OR 811, AT LEAST 48 HOURS BUT NO MORE THAN 10 WORKING DAYS BEFORE BEGINNING ANY DIGGING PROJECT.

FOR ROOF SLOPES OVER 4:12, OVERHEAD POWER LINES MUST BE 3'-0" ABOVE ROOF AT ANY POINT WHERE LINES CROSS ROOF PLANE. FOR ROOF SLOPES LESS THAN OR EQUAL TO 4:12, OVERHEAD POWER LINES MUST BE 8'-0" ABOVE ROOF AT ANY POINT WHERE LINES CROSS ROOF

PRIOR TO CONSTRUCTION, CONTRACTOR TO DETERMINE LOCATION OF UNDERGROUND GAS LINE. IF GAS LINE RUNS UNDER PROPOSED LOCATION OF ADDITION, CONTACT COLUMBIA GAS TO HAVE LINE MOVED (AT OWNER'S EXPENSE).

SOIL BEARING PRESSURE IS ASSUMED TO BE A MINIMUM OF 2,000 PSF. CONSULT ARCHITECT FOR FOOTING DESIGN WHERE SUB-STANDARD SOIL CONDITIONS EXIST. CONCRETE TO BE MIXED AND PLACED PER ACI SPECIFICATIONS.

STRUCTURAL CONCRETE: footings, interior slabs EXPOSED WALLS, GARAGE SLABS

F'C = 3000 PSI AND EXTERIOR SLABS ON GRADE F'C = 4000 PSI (5%-7% ENTRAINED AIR)ALL DEFORMED REINFORCING BARS FY = 60,000 PSI

ANCHOR BOLTS SHALL BE ASTM A307.

STRUCTURAL STEEL TO BE ASTM A36 WITH A SHOP COAT OF RUST-INHIBITIVE PAINT, EXCEPT FOR CORROSION-RESISTANT STEEL, AND STEEL TREATED WITH COATINGS TO PROVIDE CORROSION resistance.

STEEL BELOW GRADE TO BE PROTECTED BY A MINIMUM OF 3" OF CONCRETE OR 4" OF MASONRY. Joists to Beams or Joists to trusses: 16 gauge standard Joist Hangers, unless shown

OTHERWISE - AS MANUFACTURED BY SIMPSON STRONG TIE.

ROOF TRUSSES TO SUPPORTING TOP PLATES OR BEAMS - USE HURRICANE TIES, EQUAL TO SIMPSON H3, WITH ALL NAIL HOLES FILLED; ONE PER TRUSS END.

roof sheathing to Joists/Trusses:- Use 8D nails at 6" O/C at Panel edges and 12" O/C at INTERMEDIATE SUPPORTS.

FRAMING LUMBER IN CONTACT WITH MASONRY OR CONCRETE, OR EXPOSED TO WEATHER SHALL BE PRESERVATIVE PRESSURE TREATED. WHEN USING ANY PRESERVATIVE PRESSURE TREATED PRODUCT, FASTENERS (INCLUDING NAILS), ANCHORS, AND CONNECTORS SHALL HAVE ONE OF THE FOLLOWING FINISHES: HOT DIPPED ZINC-COATED GALVANIZED STEEL, STAINLESS STEEL, SILICON BRONZE, OR COPPER.

#### WOOD & PLASTICS

THIS STRUCTURE IS DESIGNED TO RESIST THE FOLLOWING MINIMUM UNIFORMLY DISTRIBUTED LIVE

ATTICS WITH LIMITED STORAGE 20 PSF ATTICS WITH FIXED STAIRS 30 PSF 40 PSF BALCONIES & DECKS ROOMS OTHER THAN SLEEPING ROOMS 40 PSF SLEEPING ROOMS STAIRS ROOF 25 PSF (GROUND SNOW LOAD)

CEILING JOISTS (HIGH SLOPE RAFTERS) 20 PSF CEILING JOISTS (LOW SLOPE/NO STORAGE) 10 PSF

90 MPH (3 SECOND GUST), EXP. B

UNLESS SPECIFICALLY STATED ON THE DRAWINGS, DIMENSIONAL LUMBER USED FOR ROOF RAFTERS, CEILING JOISTS, FLOOR JOISTS, SOLE PLATES AND WALL CAP PLATES SHALL BE SPRUCE PINE FIR NO. 2 (CANADIAN) OR BETTER, WITH A MAXIMUM MOISTURE CONTENT OF 19% AND HAVE THE FOLLOWING MINIMUM BASE DESIGN PROPERTIES:

FB 875 PSI (SINGLE MEMBER) FT 450 PSI

FV 135 PSI 425 PSI (PERPENDICULAR)

1150 PSI (PARALLEL)

1,400,000 PSI

FRAMING LUMBER USED FOR 2 x 4 OR 2 x 6 STUDS SHALL BE SPRUCE-PINE-FIR "NO. 2" OR BETTER AND HAVE A MAXIMUM MOISTURE CONTENT OF 19% AND THE FOLLOWING MINIMUM BASE

875 PSI (SINGLE MEMBER) FT 450 PSI

FV 75 PSI FC 425 PSI (PERPENDICULAR)

1150 PSI (PARALLEL)

1,400,000 PSI

LAMINATED VENEER LUMBER (LVL) SHALL BE "1.9 E MICROLAM LVL" AS MANUFACTURED BY TRUS JOIST MACMILLAN WITH THE FOLLOWING DESIGN PROPERTIES:

FB 2,650 PSI (SINGLE 12" MEMBER) FV 285 PSI

FC 750 PSI (PERPENDICULAR)

2350 PSI (PARALLEL TO GRAIN) 1.900.000 PSI

UNLESS SPECIFICALLY SHOWN OTHERWISE, DESIGN, FABRICATION AND ERECTION SHALL BE GOVERNED BY THE LATEST REVISIONS OF: NATIONAL DESIGN SPECIFICATION FOR WOOD CONSTRUCTION PRODUCT STANDARD PS-1-83 FOR CONSTRUCTION AND INDUSTRIAL PLYWOOD APA PRP-108 FOR STRUCTURAL USE PANELS, OR PS 2-92 FOR WOOD-BASED STRUCTURAL USE PANELS APA RESIDENTIAL CONSTRUCTION GUIDE

STRUCTURAL COMPOSITE LUMBER, AND STRUCTURAL GLUE-LAMINATED MEMBERS SHALL BE SUPPORTED LATERALLY AS REQUIRED BY THE MANUFACTURER.

ANY DRILLING OR NOTCHING OF THE WALL STUDS, DOUBLE TOP PLATES, JOISTS, OR OTHER

STRUCTURAL MEMBERS SHALL BE IN COMPLIANCE WITH THE BUILDING CODE.

USE SOLID BLOCKING AT BEARINGS.

USE ONE LINE OF SOLID BLOCKING OR CROSS BRIDGING AT 8'-0" O/C FOR CEILING/FLOOR JOISTS.

USE ONE TRIMMER STUD AND ONE KING STUD AT BEAM AND HEADER BEARING LESS THAN 6'-O",

AND ONE TRIMMER STUD AND TWO KING STUDS AT BEAM AND HEADER BEARING 6'-0" OR GREATER, UNLESS SHOWN OTHERWISE. WOOD PANELS FOR USE AS WALL SHEATHING AND ROOF SHEATHING SHALL BE A.P.A. RATED OF THE THICKNESS INDICATED ON THE DRAWINGS, OR AS REQUIRED FOR THE SPECIFIC APPLICATION.

PROVIDE PLYWOOD CLIPS AT UNSUPPORTED EDGES, AND AT MID-SPAN OF ROOF PANELS BETWEEN FRAMING MEMBERS SPACED GREATER THAN 16" O.C. WOOD PANELS FOR USE AS SUB-FLOORING SHALL BE A.P.A. RATED STURD-I-FLOOR WITH TONGUE

& GROOVE EDGES, OF THE THICKNESS INDICATED ON THE DRAWINGS. ALL SUB-FLOORING SHALL BE GLUED AND NAILED TO THE FLOOR STRUCTURE.

ALL INTERIOR PARTITIONS SHALL BE 2 x 4 STUDS @ 16" O.C. WITH 1/2" DRYWALL EACH SIDE, UNLESS NOTED OTHERWISE. PLAN DIMENSION IS ASSUMED TO BE 3-1/2" UNLESS NOTED OTHERWISE.

PROVIDE SOLID BLOCKING FOR ALL WALL MOUNTED ITEMS.

FRAMING LUMBER IN CONTACT WITH CONCRETE OR MASONRY, OR EXPOSED TO THE EXTERIOR SHALL BE PRESERVATIVE PRESSURE TREATED. ANY WOOD, INCLUDING EXTERIOR SHEATHING, WITHIN 6" OF FINISHED GRADE SHALL BE PRESERVATIVE-PRESSURE TREATED.

ALL EXTERIOR TRIM SHALL BE: REDWOOD, CEDAR, OR "MIRATEC" TREATED EXTERIOR COMPOSITE TRIM, WITH WHITE PINE FOR MOULDINGS, AS INDICATED ON THE DRAWINGS.

#### THERMAL & MOISTURE PROTECTION

STANDING SEAM METAL ROOFING TO BE 24 GUAGE GALVANIZED STEEL. PAN WIDTH TO BE 16" AND SEAM HEIGHT TO BE 1". ALL METAL CONNECTORS TO BE FULLY COMPATIBLE WITH ROOF MATERIAL, TO PREVENT GALVANIC CORROSION.

ASPHALT SHINGLE ROOFING BLEND, COLOR AND WEIGHT SHALL MATCH EXISTING. ASPHALT SHINGLE ROOFING SHALL BE INSTALLED OVER ONE LAYER OF 15# ROOFING FELT AND AS RECOMMENDED BY THE MANUFACTURER. PROVIDE ICE AND WATER SHIELD "SELF-SEALING" MEMBRANE AT ALL EAVES AND VALLEYS. MEMBRANE TO BE 36" WIDE AT ALL VALLEYS, AND IS TO EXTEND FROM THE EAVE'S EDGE TO A POINT AT LEAST 24" INSIDE THE EXTERIOR WALL LINE OF

ROOFING FOR FLAT ROOF AREAS SHALL BE FULLY ADHERED 60 MIL EPDM SINGLE PLY MEMBRANE. PROVIDE TAPERED SLEEPERS WITH A MINIMIUM SLOPE OF 1/2" PER FOOT BELOW ALL MEMBRANE.

PROVIDE CONTINUOUS HALF-ROUND GUTTERS TO MATCH EXISTING AT ALL ROOF EAVES. PROVIDE CORRUGATED RECTANGULAR ALUMINUM DOWNSPOUTS AT LOCATIONS AS INDICATED ON THE DRAWINGS. DOWNSPOUTS SHALL RUN TO A LOCATION APPROVED BY THE CITY.

ASPHALT SHINGLES SHALL BE TESTED IN ACCORDANCE WITH ASTM D 7158. SHINGLES SHALL MEET THE CLASSIFICATION REQUIREMENTS FOR THE APPROPRIATE MAXIMUM BASIC WIND SPEED.

EXTERIOR SIDING TO BE FIBER CEMENT. SEE ELEVATIONS FOR EXPOSURE HEIGHT. COLOR TO BE SELECTED BY OWNER.

ALL NEW EXTERIOR WOOD TRIM & SIDING TO BE PAINTED. PAINT WITH ONE COAT OF MANUFACTURER'S BEST EXTERIOR WOOD PRIMER AND TWO COATS MANUFACTURER'S BEST EXTERIOR LATEX SEMI-GLOSS (TRIM) AND LATEX SATIN (SIDING) PAINT. COLOR AS SELECTED BY THE OWNER.

AN APPROVED WATER-RESISTIVE BARRIER (SUCH AS TYVEK HOUSE WRAP) SHALL BE APPLIED OVER SHEATHING OF ALL EXTERIOR WALLS. SUCH MATERIAL SHALL BE APPLIED HORIZONTALLY, WITH THE UPPER LAYER LAPPED OVER THE LOWER LAYER NOT LESS THAN 2". WHERE JOINTS occur, Barrier shall be lapped not less than 6". The Barrier shall be continuous to THE TOP OF THE WALL, AND TERMINATED AT PENETRATIONS AND BUILDING APPENDAGES. MINIMUM PERM RATING SHALL BE 25.

#### DOORS & WINDOWS

WINDOWS SHALL BE AS MANUFACTURED BY MARVIN WINDOWS & DOORS. PROVIDE WINDOW UNITS OF SIZES INDICATED ON THE DRAWINGS IN THE "ARCHITECT SERIES." WITH INSULATING LOW-E II GLASS, SIMULATED DIVIDED LITES WITH SPACER BARS, TRIM TO MATCH EXISTING, FULL SCREENS, BARE WOOD INTERIOR AND PRIMED EXTERIOR. HARDWARE COLOR AS SELECTED BY THE OWNER. WINDOW MANUFACTURER SHALL PROVIDE TEMPERED GLASS AS REQUIRED BY CODE AT ALL HAZARDOUS LOCATIONS.

EXTERIOR FRENCH DOORS TO BE AS MANUFACTURED BY MARVIN WINDOWS & DOORS. PROVIDE DOOR UNITS OF SIZES INDICATED ON THE DRAWINGS IN THE "ARCHITECT SERIES," WITH insulating low-e II glass, simulated divided lites, trim to match existing, bare wood INTERIOR AND PRIMED WOOD EXTERIOR, WEATHERSTRIPPING, THRESHOLD, AND HARDWARE COLOR AS SELECTED BY THE OWNER. INCLUDE FULL SCREEN DOORS AT ALL OPERABLE LOCATIONS. WINDOW MANUFACTURER SHALL PROVIDE TEMPERED GLASS AS REQUIRED BY CODE AT ALL HAZARDOUS LOCATIONS.

INTERIOR DOORS TO BE SOLID WOOD, WITH TWO-PANEL DESIGN, WOOD SPECIES, FINISH AND HARDWARE TO MATCH EXISTING. DOOR SIZES AS INDICATED ON THE DRAWINGS.

ALL BATHROOMS TO HAVE MOISTURE-RESISTANT OR PAPERLESS DRYWALL. PROVIDE "DUROCK" TILE BACKER BOARD IN LIEU OF DRYWALL AT ALL WALL LOCATIONS REQUIRING A TILE FINISH.

ALL INTERIOR COLORS AND FINISHES, NOT SPECIFIED HEREIN, TO BE SELECTED BY THE OWNER.

WOOD MOULDING PROFILES ARE SPECIFIED AS MANUFACTURED BY CAPITAL CITY MILLWORK, WESTERVILLE, OHIO. WOOD SPECIES TO BE POPLAR FOR INTERIOR APPLICATIONS AND WHITE PINE FOR EXTERIOR APPLICATIONS UNLESS NOTED OTHERWISE. EQUAL PRODUCTS BY OTHER MANUFACTURERS ARE ALSO ACCEPTABLE.

## MECHANICAL

GAS PIPING SHALL NOT PENETRATE BUILDING FOUNDATION WALLS AT ANY POINT BELOW GRADE. GAS PIPING SHALL ENTER AND EXIT A BUILDING AT A POINT ABOVE GRADE, AND THE ANNULAR SPACE BETWEEN THE PIPE AND THE WALL SHALL BE SEALED.

PLUMBING ENGINEERING TO BE PROVIDED BY PLUMBING SUB-CONTRACTOR, COORDINATION BY THE GENERAL CONTRACTOR. PROVIDE PLUMBING FIXTURES AT LOCATIONS INDICATED ON THE DRAWINGS, AS SELECTED BY THE OWNER, AND AS NECESSARY TO COMPLETE INSTALLATION.

HVAC LAYOUT AND ENGINEERING TO BE PROVIDED BY HVAC SUB-CONTRACTOR, COORDINATION BY THE GENERAL CONTRACTOR.

SUPPLY DUCTS IN ATTICS SHALL BE INSULATED TO A MINIMUM OF R-8. ALL OTHER DUCTS SHALL BE INSULATED TO A MINIMUM OF R-6.

AIR DUCTS SHALL BE SEALED AND DUCT TIGHTNESS SHALL BE VERIFIED BY EITHER OF THE FOLLOWING TESTING OPTIONS: 1) POST CONSTRUCTION TEST, OR 2) ROUGH-IN TEST.


HVAC SUB-CONTRACTOR TO EVALUATE CONDITION & ADEQUACY OF THE EXISTING SYSTEM, AND PROVIDE RECOMMENDATIONS FOR NECESSARY CHANGES TO OWNER WITH BID. NEW EQUIPMENT TO HAVE THE FOLLOWING MINIMUM REQUIREMENTS: FURNACE = 90%


CATEGORY IV CONDENSING APPLIANCES SHALL BE PROVIDED WITH AN AUXILIARY DRAIN PAN.


PROVIDE PRICING FOR OPTIONS SUCH AS ELECTRONIC AIR CLEANER & HUMIDIFIER.

EFFICIENT, A/C CONDENSER UNIT = 15 SEER.



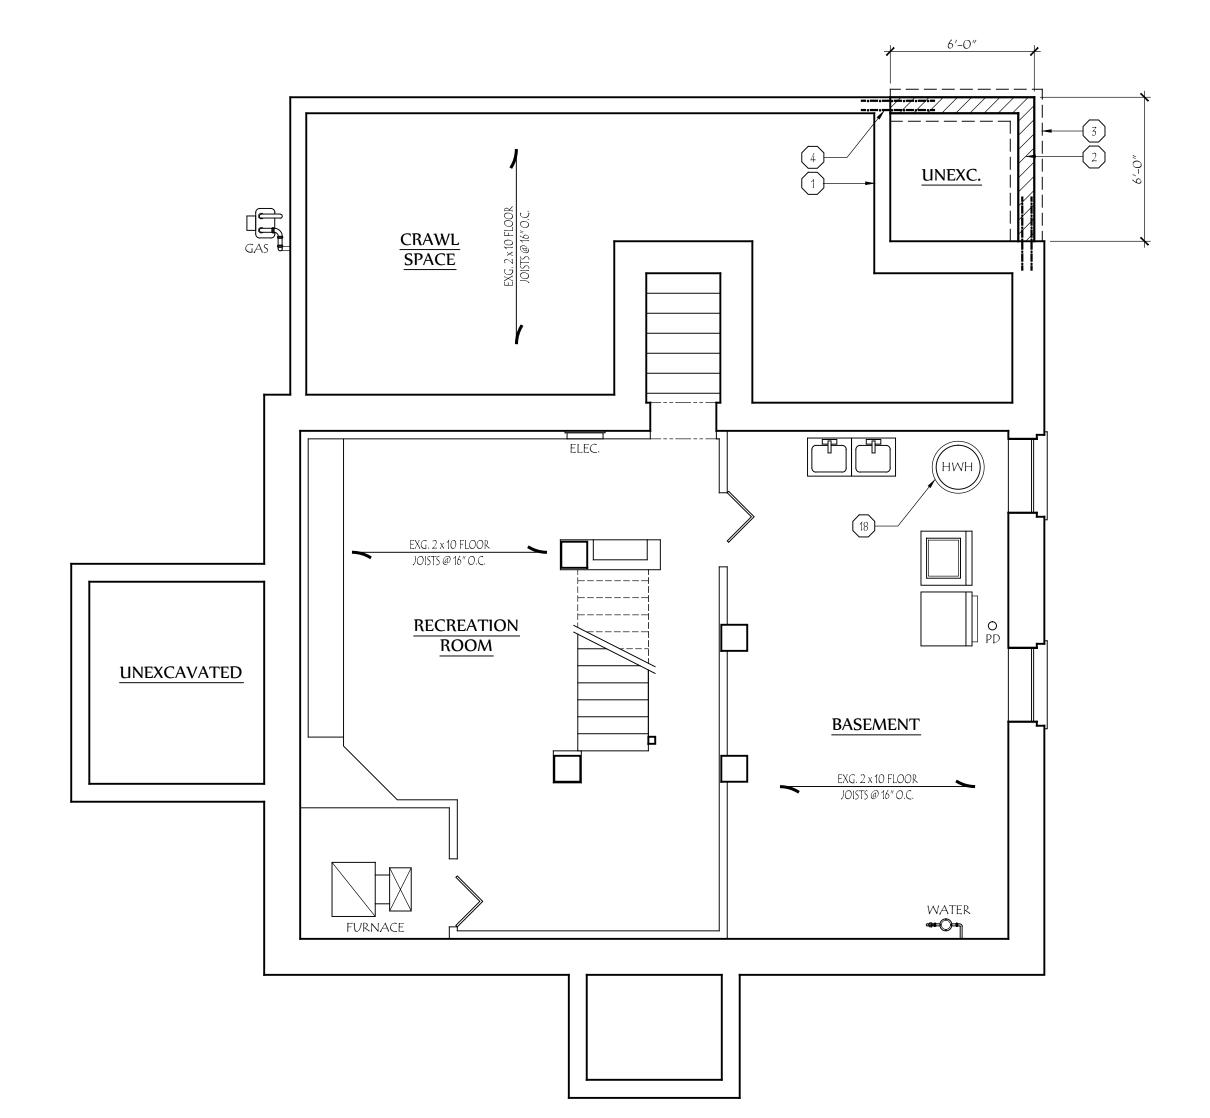

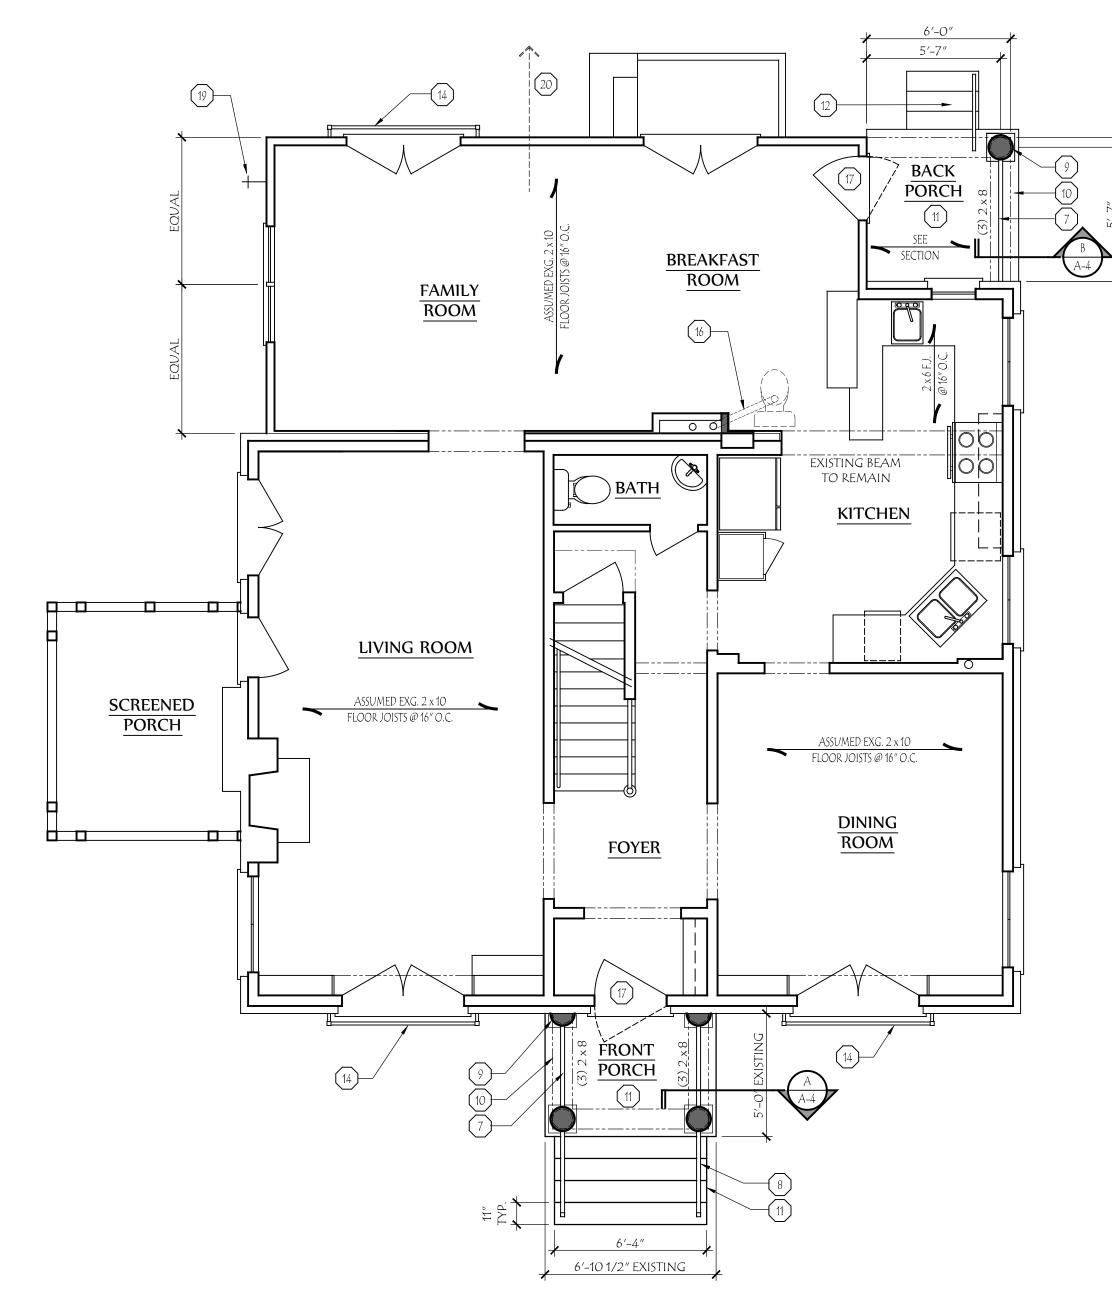

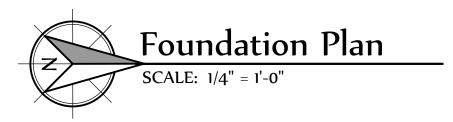





Avenue Bexley, Ohio 43209 614.371.3
vww.LauerhassArchitecture.com
my@LauerhassArchitecture.com
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# 11808 11808 CARED ARCHIVE

( PLACE 43209

31 BULLITT PARK 1 BEXLEY, OHIO 4

RENOVATION FOR:
AUCH RESIDENCE

12. TEMPORARY WOOD STEPS & HANDRAIL. FINAL STEP DESIGN BY OTHERS.

13. NOT USED.

14. NEW WROUGHT IRON GUARDRAIL.

FLOOR PLAN CODED NOTES (DRAWING SHEET A-1 ONLY)

TO REMAIN.

5. NOT USED.

6. NOT USED.

OWNER.

THE OWNER.

SHEET A-3.

1. UNSHADED WALLS INDICATE EXISTING CONSTRUCTION

 HATCHED WALLS INDICATE NEW 8" THICK CONCRETE BLOCK FOUNDATION WALL.

3. 8" DEEP x 16" WIDE CONCRETE FOOTING WITH (2) #5 REBAR CONTINUOUS.

7. WROUGHT IRON GUARDRAIL: 36" ABOVE FINISHED

FLOOR, WITH BALUSTERS SPACED AT 5" O.C. MAXIMUM.

RAIL & BALUSTER STYLE TO BE AS SELECTED BY THE

8. WROUGHT IRON HANDRAIL: 34" ABOVE LEADING EDGE

MAXIMUM. RAIL & BALUSTER STYLE TO BE AS SELECTED BY

OF TREADS, WITH BALUSTERS SPACED AT 5" O.C.

9. 12" DIAMETER DORIC COLUMN / HALF COLUMN.

10. 10" WIDE BEAM ABOVE: SEE TYPICAL WALL SECTIONS

11. POURED CONCRETE LANDING AND STEPS: MAXIMUM RISER HEIGHT TO BE 8".

(2) NO. 5 REBAR - MINIMUM 36" LONG.

4. PIN NEW FOOTING INTO EXISTING FOUNDATION WITH

15. NOT USED.

16. NEW TOILET LOCATION ABOVE. RUN DRAIN INTO EXISTING CHASE, AS FAR SOUTH AS POSSIBLE. (FOR FUTURE KITCHEN RENOVATION)

17. NEW ENTRY DOOR & STORM DOOR.

18. NEW HOT WATER HEATER TO VENT THROUGH SIDE WALL, DUE TO REMOVAL OF EXISTING CHIMNEY.

19. NEW HOSE BIB LOCATION.

20. NEW GAS LINE TO BE RUN TO NEW GRILL LOCATION. CONSULT OWNER FOR FINAL LOCATION.

Project Number: 17-005

THE


Revisions:

Date: 12 February 2018

Drawing Title:
Foundation Plan
First Floor Plan

Sheet Number:



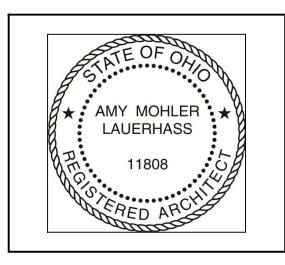

# RESIDEN T PARK OHIO 4 RENOVATION AUCH 31 BULLIT' BEXLEY, ( THE

Project Number: 17-005

**Revisions:** 

Date: 12 February 2018

Drawing Title: Second Floor Plan Roof Plan

> Sheet Number: A-2

FLOOR PLAN CODED NOTES (DRAWING SHEET A-2 ONLY)

- UNSHADED WALLS INDICATE EXISTING CONSTRUCTION TO REMAIN.
- 2. SHADED WALL INDICATES NEW STUD WALL: 2 x 4 WOOD STUDS AT 16" O.C. WITH 1/2" DRYWALL ON ALL INTERIOR SURFACES AND 1/2" PLYWOOD SHEATHING ON ALL EXTERIOR SURFACES. TYPICAL UNLESS NOTED OTHERWISE.
- 3. WOOD STUD INFILL OF EXISTING WALL OPENING: PATCH SURFACES TO MATCH EXISTING.
- 4. SINGLE CLOSET ROD & SHELF.
- 5. DOUBLE CLOSET RODS AND SHELVES.

6. 12" DEEP ADJUSTABLE CLOSET SHELVING.

- 7. MIRROR LOCATION. STYLE AND SIZE AS SPECIFIED BY THE
- 8. VANITY BASE AND COUNTERTOP.
- 9. TOILET & SEAT.
- 10. COUNTER LAVATORY AND FAUCET.
- 11. FULL HEIGHT LINEN CABINET.
- 12. SUGGESTED TOWEL BAR LOCATION.
- 13. 44" x 60" CUSTOM SHOWER BASE.
- 14. FRAMELESS GLASS SHOWER ENCLOSURE AND DOOR.
- 15. HALF WALL BEHIND BATHROOM DOOR, WITH SOLID SURFACE CAP.
- 16. FIELD VERIFY: CENTER WITH KITCHEN WINDOW BELOW.
- 17. EXISTING ATTIC PULL-DOWN STAIR TO REMAIN.
- 18. EXISTING CLOSET ATTIC-ACCESS PANEL TO BE REMOVED.
- PATCH SURFACES TO MATCH EXISTING. 19. SUGGESTED LOCATION FOR NEW FURNACE TO
- CONDITION SECOND FLOOR. FINAL LOCATION TO BE DETERMINED BY HVAC CONTRACTOR.
- 20. NEW DIMENSIONAL ASPHALT SHINGLE ROOFING ON NEW ROOF AREA BELOW. MATCH EXISTING.

21. FULLY ADHERED 60 MIL, SINGLE PLY EPDM ROOF

- MEMBRANE ON 2 X SLEEPERS, ON ROOF AREA BELOW. CREATE SLOPE FOR PROPER DRAINAGE.
- 22. NEW STANDING-SEAM METAL ROOF ON NEW PORCH ROOF STRUCTURE.
- 23. DASHED LINE INDICATES EXTERIOR WALL BELOW.
- 24. NEW METAL HALF-ROUND GUTTER TYPICAL. COLOR TO MATCH EXISTING.
- 25. NEW RECTANGULAR ALUMINUM DOWNSPOUT LOCATION. MATCH EXISTING. SEE NOTE BELOW.
- 26. REINSTALL EXISTING GUTTER AFTER PORCH
- CONSTRUCTION.
- 27. EXISTING GUTTER TO REMAIN. 28. EXISTING DOWNSPOUT TO REMAIN.
- 29. EXISTING DOWNSPOUT TO REMAIN. SEE NOTE BELOW.
- 30. CONNECT NEW PORCH GUTTER INTO EXISTING.
- 31. EXISTING SECTION OF DAMAGED SOFFIT TO BE REPAIRED. (OWNER HAS EXTRA SOFFIT MATERIAL.)
- 32. EXISTING SECTION OF ROOF TO BE REPAIRED WHERE CHIMNEY WAS REMOVED.
- 33. 32" x 60" STANDARD TUB/SHOWER & FAUCET WITH CERAMIC TILE SURROUND.
- 34. INSULATE AROUND ENTIRE NEW BATHROOM WITH 3-1/2", R-15 FIBERGLASS BATT INSULATION.
- 35. NEW PORCH GUTTER TO CONTINUE ACROSS ADDITION TRIM BOARD, AND CONNECT INTO NEW GUTTER.


GENERAL NOTE:


CONTRACTOR TO ASSESS CONDITION & LOCATION OF EXISTING UNDERGROUND STORM DRAINS, AND PROVIDE


And existing downspouts.

1. REPAIR/REPLACE EXISTING LINES, AND CONNECT ALL NEW

2. PROVIDE DRY WELL IN REAR YARD TO COLLECT RAIN FROM BACK HALF OF HOUSE.

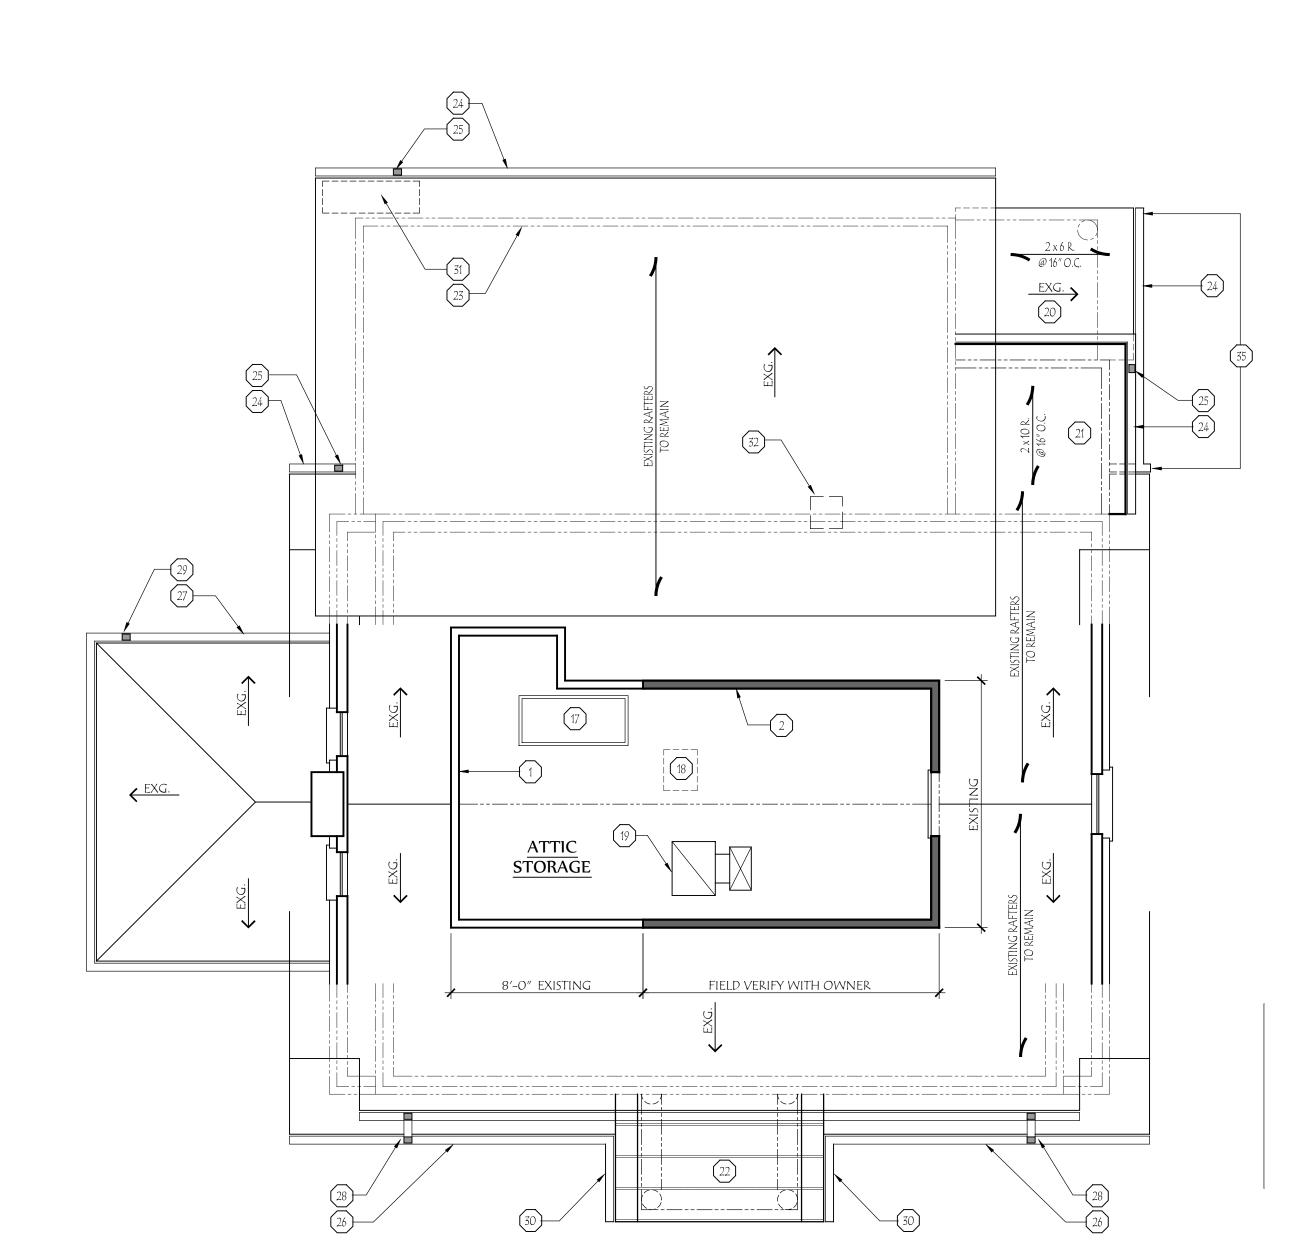


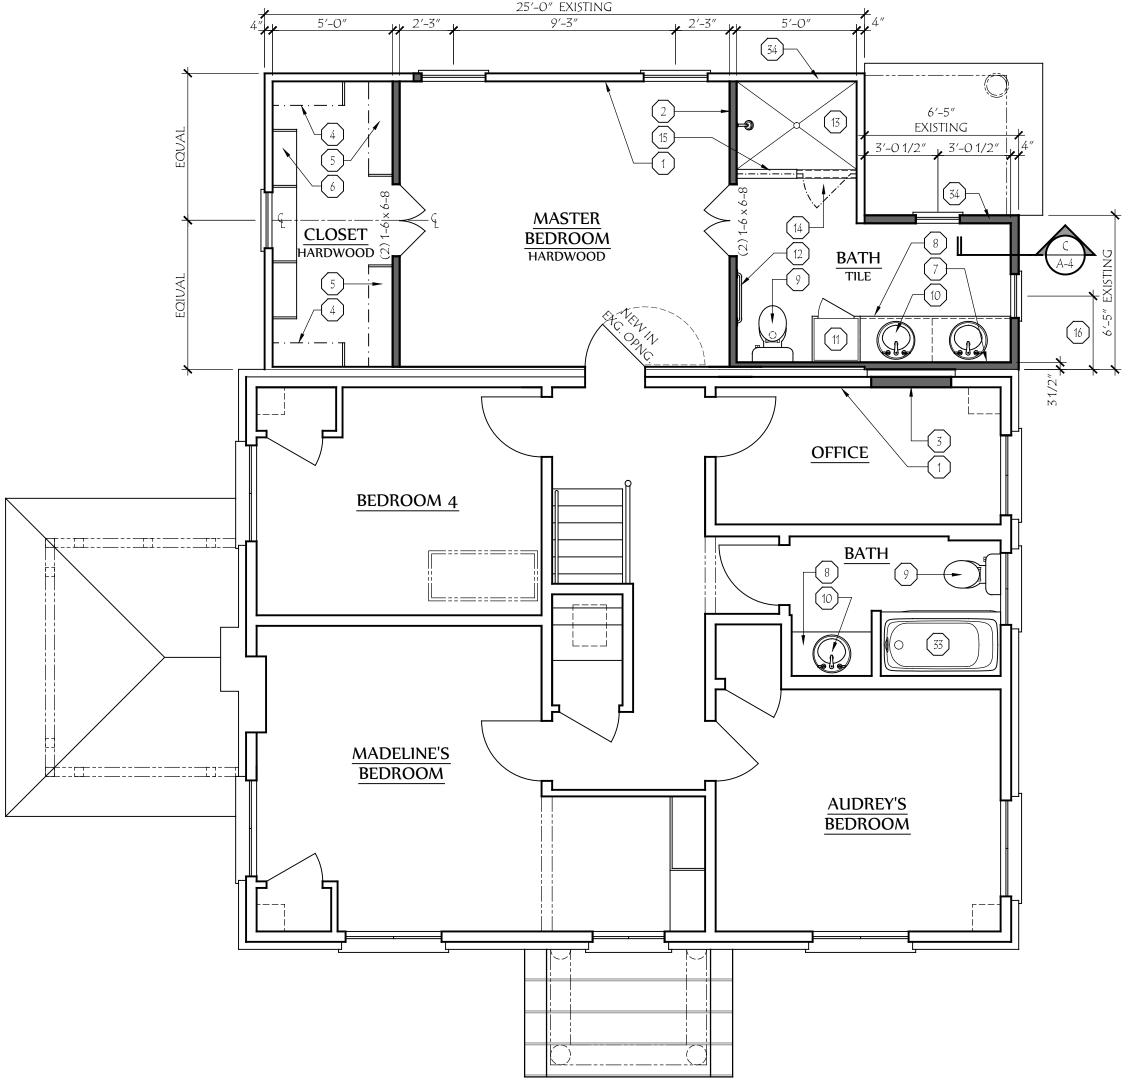

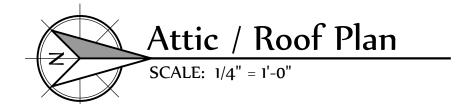





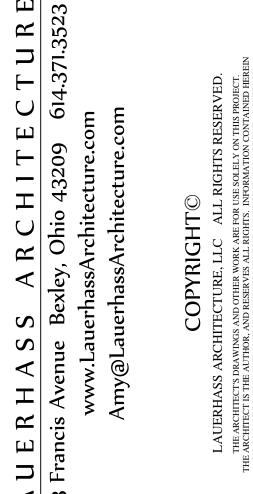

AMY MOHLER LAUERHASS

11808

RENOVATION FOR:

THE AUCH RESIDENCE

31 BULLITT PARK PLACE
BEXLEY, OHIO 43209

Project Number: 17-005

Revisions:

Revisions:

Date:

12 February 2018

Drawing Title:
Exterior
Elevations

Sheet Number:

NEW WINDOW IN DAY ING OPENING

BY THE STATE OF THE STATE



SCALE: 1/4'' = 1'-0''



**South Elevation** 

SCALE: 1/4" = 1'-0"

## EXTERIOR ELEVATION CODED NOTES (DRAWING SHEET A-2 ONLY)

- 1. EXISTING CONSTRUCTION TO REMAIN.
- 2. NEW DIMENSIONAL ASPHALT SHINGLE ROOFING TO MATCH EXISTING.
- 3. 60 MIL, FULLY ADHERED, SINGLE PLY MEMBRANE ROOFING ON TAPERED SLEEPERS.
- 4. STANDING SEAM METAL ROOF WITH 16" PAN
- NEW PAINTED FIBER CEMENT SIDING WITH 4" EXPOSURE - SECOND FLOOR.
- NEW PAINTED FIBER CEMENT SIDING WITH 7" EXPOSURE - SECOND FLOOR.
- 7. POURED CONCRETE PORCH SLAB & STEPS.
- 8. NEW CLAD WOOD WINDOW UNIT.
- 9. NEW ENTRY DOOR.
- 10. FLAT CASING TO MATCH EXISTING WINDOW TRIM.
- 11. HALF ROUND GUTTER ON 1 x 6 FASCIA BOARD. COLOR TO MATCH EXISTING. SEE TYPICAL WALL SECTIONS FOR DETAILS.
- 12. WROUGHT IRON RAILING: HANDRAIL AT 34" ABOVE LEADING EDGE OF TREADS,A ND GUARDRAIL AT 36" ABOVE FINISHED FLOOR.
- 13. 12" DIAMETER COLUMN/PILASTER: SEE TYPICAL WALL SECTIONS FOR DETAILS.
- 14. DOWNSPOUT LOCATION SEE ROOF PLAN FOR DETAILS.
- 15. 5/4" x 6 CORNER TRIM.
- 16. NEW EXTERIOR LIGHT FIXTURE, TO BE SELECTED BY OWNER.
- 17. NEW PANELED SHUTTERS TO REPLACE EXISTING. COLOR TO BE SELECTED BY OWNER.
- 18. NEW FIXED WROUGHT IRON GUARDRAIL.
  TOP OF RAIL TO BE 36" ABOVE FIRST FLOOR
- 19. NEW ROUND PORCH ROOF -SEE TYPICAL WALL SECTION FOR DETAILS.
- 20. EXISTING CHIMNEY TO BE REMOVED THROUGH ROOF. PATCH SURFACES TO MATCH EXISTING.
- 21. PAINTED FIBER CEMENT BAND BOARD AT THE SECOND FLOOR LEVEL, AT CHANGE IN SIDING
- 22. FIBER CEMENT SIDING OVER EXISTING BRICK
- 23. TEMPORARY WOOD STEPS & HANDRAIL. FINAL STEP & PATIO DESIGN BY OTHERS.

veneer – this section only.

- 24. RAKE TRIM TO MATCH EXISTING ORIGINAL
- HOUSE.
- 25. NEW PORCH GUTTER TO CONTINUE ACROSS
  ADDITION TRIM BOARD, AND CONNECT INTO
  NEW GUTTER ON EXISTING SECTION OF



West (Rear) Elevation



East (Front) Elevation











# PUBLIC NOTICE CITY OF BEXLEY ARCHITECTURAL REVIEW BOARD

The Bexley Architectural Review Board (ARB) will hold a Public Meeting on the following case on <u>Thursday, March 12, 2020 at 6:00 PM</u>, in City Council Chambers, Bexley City Hall, 2242 East Main Street, Bexley, Ohio.

The APPLICANT or REPRESENTATIVE must be present at the Public Hearing. The Board may dismiss, without hearing, an application if the applicant or authorized representative is not in attendance. The Board may move to consider the application in those circumstances where dismissal without hearing would constitute a hardship on the adjoining property owners or other interested persons.

a. Application No.: ARB-20-7Applicant: David Pryor

Owner: Pryor Development LLC

Location: 752 Vernon Rd.

**ARB Request**: The applicant is seeking architectural review and approval

to allow an addition to the rear of the existing principal structure.

A copy of this application is available for review in the Building Department office during the hours of 8:00 A.M. until 4:00 P.M. If you have any questions, please call the Bexley Building Department at 559-4240.

Mailed by: 02-27-2020

\*(ARB) Architectural Review Board
Application - Major Review (for
Additions to Principal and Accessory
structures and New Principal
Structures that DO NOT REQUIRE A
VARIANCE. (You must proceed to the
BZAP application if you wish to
request a variance from the Zoning
Code) ARB meets on the 2nd
Thursday of the month (except
December) applications are due 4
weeks prior.

#### **Applicant**

Ŋ

david pryor

614-560-6627

@ dpryor@davidpryorlaw.com

#### Location

752 VERNON RD Bexley, OH 43209

### **ARB-20-7**

Status: Active

Submitted: Feb 12, 2020

#### A.1: Project Information

Brief Project Description - ALSO PROVIDE 2 HARD COPIES (INCLUDING PLANS) TO THE BUILDING DEPARTMENT..

275 sq' addition on rear of house

Architecture Review Demolition

true false

Planned Unit Dev Rezoning false false

#### A.1: Attorney / Agent Information

Agent Name Agent Address

-

Agent Email Agent Phone

-- -

Property Owner Name Property Owner phone

<del>--</del>

If owner will not be present for review meeting, you must submit a permission to represent signed by the current owner.

#### A.2: Fee Worksheet

Estimated Valuation of Project Minor Architectural Review

90000 false

Major Architectural Review Variance Review - Fill out a BZAP Application instead.

true false

Zoning Zoning Review Type

false --

Sign Review and Architectural Review for Commercial Projects

false

Review Type

\_\_

Appeal of ARB decision to BZAP

false

Appeal of BZAP decision to City Council

false

bexley

**B: Project Worksheet: Property Information** 

Occupancy Type Zoning District

Residential

**Use Classification** 

R-1 (25% Building and 40% Overall)

**B: Project Worksheet: Lot Info** 

Width (ft) Depth (ft)

21 6

Total Area (SF)

275

**B: Project Worksheet: Primary Structure Info** 

Existing Footprint (SF) Proposed Addition (SF)

1268 138

Removing (SF)

Type of Structure

40 wood frame addition

Proposed New Primary Structure or Residence (SF)

Total Square Footage

276 1544

B: Project Worksheet: Garage and/or Accessory Structure Info (Incl. Decks, Pergolas, Etc)

Existing Footprint (SF) Proposed Addition (SF)

280

New Structure Type Ridge Height

Proposed New Structure (SF) Is there a 2nd Floor

- No

Total of all garage and accessory structures (SF)

Total building lot coverage (SF)

280 280

Total building lot coverage (% of lot)

Is this replacing an existing garage and/or accessory structure?

1824 --

#### **B: Project Worksheet: Hardscape**

**Existing Driveway (SF)** 

360

**Existing Private Sidewalk (SF)** 

Total Hardscape (SF)

540

**Existing Patio (SF)** 

Proposed Additional Hardscape (SF)

#### **B: Project Worksheet: Total Coverage**

Total overall lot coverage (SF)

2364

Total overall lot coverage (% of lot)

44

#### C.1 Architectural Review Worksheet: Roofing

Roofing

true

**Existing Roof Type** 

Std. 3-tab Asphalt Shingle

**New Single Manufacturer** 

**Existing Window Type** 

Certainteed

Structure

House or Principal Structure

**New Roof Type** 

Arch. Dimensional Shingles

**New Roof Style and Color** 

match existing grey

#### C.1 Architectural Review Worksheet: Windows

**Windows** 

true

Structure House or Principal Structure

**Existing Window Materials** 

Double Hung Vinyl Clad Wood

**New Window Manufacturer** New Window Style/Mat./Color

Marvin match existing white

#### C.1 Architectural Review Worksheet: Doors

**Doors** 

true

**Existing Entrance Door Type** 

Insulated Metal

**Door Finish** 

**Proposed Door Style** 

Structure

House or Principal Structure

**Existing Garage Door Type** 

**Proposed Door Type** 

6 panel

**Proposed Door Color** 

match existing white

C.1 Architectural Review Worksheet: Exterior Trim

Exterior Trim Existing Door Trim

true Vinyl

Proposed New Door Trim Existing Window Trim

match existing Vinyl

Proposed New Window Trim Trim Color(s)

match existing white

Do the proposed changes affect the overhangs?

No

C.2 Architectural Review Worksheet: Exterior Wall Finishes

Exterior Wall Finishes Existing Finishes

true Vinyl Siding

Existing Finishes Manufacturer, Style, Color Proposed Finishes

beige vinyl Vinyl Siding

**Proposed Finishes Manufacturer, Style, Color** 

match existing

#### D: (Staff Only) Tree & Public Gardens Commission Worksheet

Design plan with elevations (electronic copy as specified in instructions plus 1 hard copy)

instructions plus 1 hard copy)

Applicant has been advised that Landscape Designer/Architect must be present at meeting

false

false

Design Specifications as required in item 3 in "Review Guidelines and List of Criteria" above

false

#### Attachments (5)

pdf Architectural Plans which include Exterior Elevations and floor plans of existing and proposed

Feb 12, 2020

pdf Landscape Plan for New Principal Structures

Feb 12, 2020

pdf Photographs (required)

Feb 12, 2020

pdf Site Plan

Feb 12, 2020

pdf Permission for Agent to represent owner.

Feb 12, 2020

Tim	eline
	Payment
	Status: Paid February 12th 2020, 1:12 pm
	Zoning Officer
	Status: Completed March 4th 2020, 2:44 pm
	Assignee: Kathy Rose
	Design Planning Consultant
	Status: In Progress
	Assignee: Karen Bokor
	Architectural Review Board
	Status: In Progress
	Board of Zoning and Planning
	Status: In Progress
	City Council
	Status: In Progress
	Tree Commission
	Status: In Progress
	Arborist
	Status: In Progress



# **ADDITION AND RENOVATION**

## 752 VERNON AVE.

#### SCOPE OF WORK

EXISTING REAR PORCH TO BE REMOVED AND THE CONSTRUCTION OF A TWO STORY ADDITION TO THE REAR OF THE HOUSE. THE COMPLETE REMODEL OF THE EXISTING STRUCTURE.

CLIMATIC AND GEOGRAPHIC DESIGN CRITERIA							
ROOF SNOW VIND LOAD (LB DESIGN	SEISMIC	SUBJECT TO DAMAGE FROM		SUBJECT TO DAMAGE FROM		WINTEN DESIGN	
		CONDITIONS BY ZONE	WEATHERING	#ROST	TEMMTE	DECAY	FACILITES
20	90 MPH	-1	SEVERE	35"	YES	YES	\$005.F

ADDITION TO BE DESIGNED AND BUILT TO THE FOLLOWING CODES 2019 RC02018 IECC2017 Ohio Plumbing Code and 2017 NEC

AVEX SONDALE			
NAME	APPEA		
REAR FORCH:	23,2 % 5		
ALTUDOK ADDITION	137.2 % 5		
HE FLOOR ADDITION	117.2 Mg 5		
STANK UPICE	SIS IN		

INDEX	
COVER PAGE	1
DEMOLITION PLANS	2
FOUNDATION AND FLOOR PLANS	3
EXTERIOR ELEVATIONS	4
STRUCTURAL PLANS	5

#### GENERAL NOTES:

LOAD DESIGN PARAMETERS

ROOMS: IST FLOOR 40 PSF LL. IO PSF D.L. 2ND FLOOR 30 PSF LL 10 PSF D.L.
ROOF: 25 PSF LL 10 PSF D.L.

ATTIC: 20 PSF LL 10 PSF D.L.
WIND: 13 PSF
ANTICIPATED SOIL BEARING CAPACITY 1500PSF 2 DIMENSIONAL LUMBER SHALL HAVE THE FOLLOWING PROPERTIES

ALL STUDS TO BE STUD GRADE OR BETTER.
ALL LUMBER SHALL BE 72 SPF OR HAVE THE SAME DESIGN VALUES OR BETTER,
ALL DIMBOSONAL LUMBER SHALL HAVE A MAX, MOISTURE CONTENT

OF ISA.

THE POLLOUING FASTING SCHEDULE OUTLINES THE MIN. REQUIREMENTS, (RENARING SHANK NALLS CUINCOPHON WIRE NALLS)

A BURD-LOOP TO JOBIT LOUIL AND HOT REN 9 6'

B. BOLE PLATES TO SUBPLOOM, GUIE AND HED CUIN 9 8' O.C.,

C. STLDS TO SOLE PLATE 3-HED CUIN

D. STLDS TO SOLE PLATE 3-HED CUIN

E. STLD TO STLD 9 FLATES 3-HED CUIN

E. STLD TO STLD 9 FLATES 3-HED CUIN

F. ROOF SHEATHING TO TRUSSES HD CUIN 9 4' C.C.,

F. ROOF SHEATHING TO TRUSSES HD CUIN 9 4' C.C.,

H. WOOD NALES TO TO FO STEEL BEAST HOTS TO ANCHOR HD,S "

H. WOOD NALES TO TO FO STEEL BEAST HOTS AND STEEL STEEL SHEAT ST.

4. ALL LIVL BEAMS SHALL BE FASTEN PER TRANSACTURES SPECS,

TRUSSES SHALL DESIGNED BY A STRUCTURAL ENGINEER REGISTERED IN THE STATE OF OHIO, ROOF TRUSSES SHALL BE DESIGNED FOR THE

FOLLOWING LOADS

TOP CHORD D.L. 10 PSF BOTTOM CHORD D.L. 20 PSF 4 LL 20 PSF IN 42' PANELS.

BOTTOM CHORD D.L.» 20 PSF 4 LL. 20 PSF IN 47 PANELS, FRESTOPPING SHALL BE PROVIDED UITH NOCOMBUSTIBLE MATERIAL IN THE FOLLOWING LOCATIONS.

A CONCEAUGH OPACES OF STLD WALLS AND PARTITIONS AT THE CELING LINE MAY AT THE FLOOR LEVEL.

CHING LINE MAY AT THE FLOOR LEVEL.

AND MORROWALL AND MORROWALL AND MORROWALL AND MORROWALL AND MORROWALL AND FLOOR WALL AND MORROWALL AND FLOOR WALL AND MORROWALL AND THE CELING AND FLOOR NITRORECTIONS.

C. OPENINGS AROUND PIPES, DUCTS, FIREPLACE CHIMNEYS AT CELING AND FLOOR INTERSECTIONS.

ALL INTERIOR WALLS ARES 12" UNLESS NOTED OTHERWISE.

HANDRAIL TO BE CIRCULAR! 1/4"-2"IN DIAMETER

IO, INSTALL DBL, RIM JOIST WHERE FLOOR JOIST RUN PARALLEL TO FOUNDATION.

BLOCK ALL POINT LOADS SOLID TO FOUNDATION


16. ANY FOAM PLASTIC INSULATION EXPOSED IN THE ATTIC DUELLING UNIT OR CRAWL SPACE SHALL HAVE A FLAME WELAD RATING NOT TO EXCEED 25 AND A SMOKE DEVELOPED FACTOR OF NOT TO Pod

# ADDITION AND RENOVATION ⋛ 52 VERNON


DATE2/1/20


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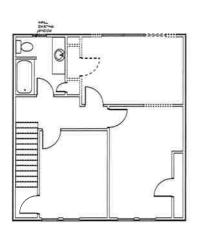
1 OF 5

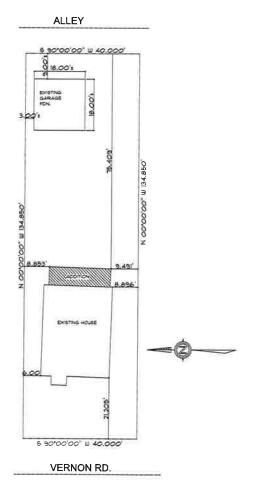

SITE PLAN



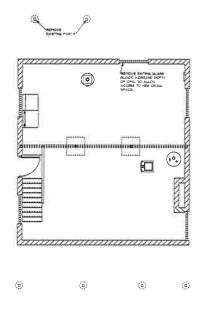

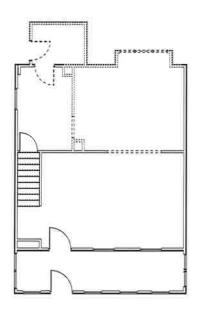

WALL LEGEND

Delta Digital Marina

Delta Dig

FOUNDATION DEMOLITION PLAN

16T FLOOR DEMOLITION PLAN

2ND FLOOR DEMOLITION PLAN

A.E. 14" - 14"



ADDITION AND RENOVATION

OF


752 VERNON AVE.




DATE: 2/1/20

2 OF 5


DRAWN BY: JP

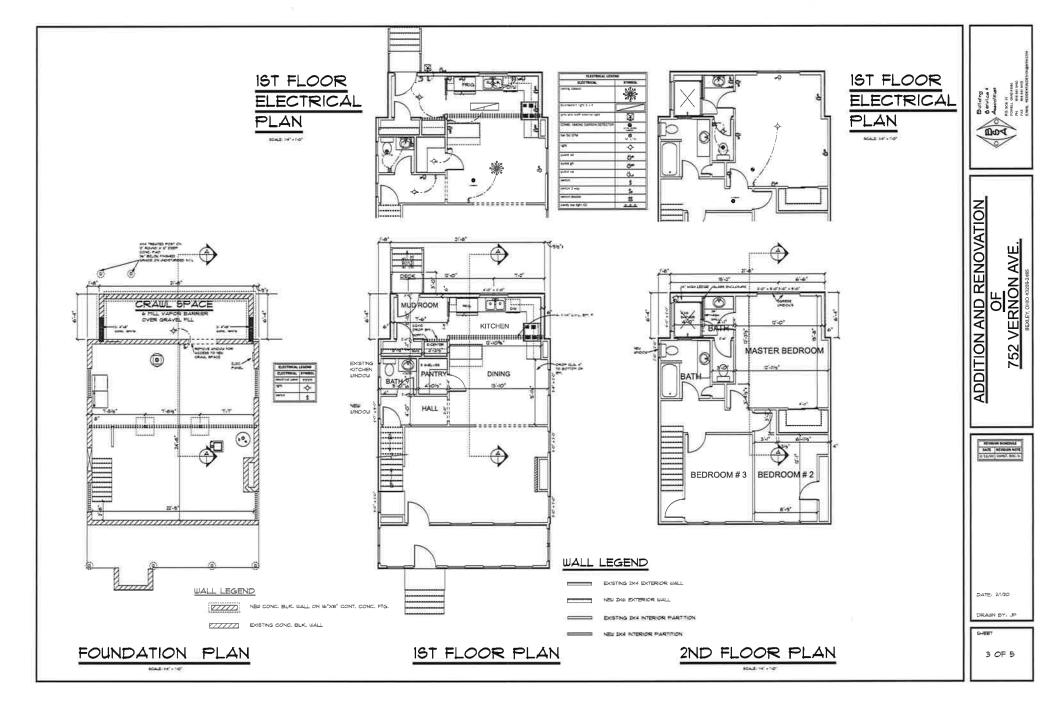



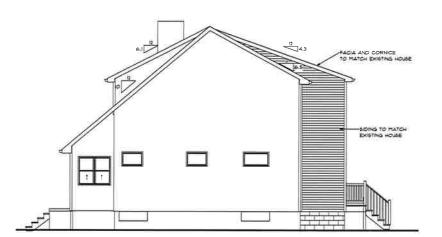



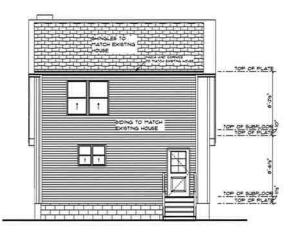

### REAR ELEVATION




L.Y.L. BM. OYER KITCHEN DESIGN CALCULATIONS



ADDITION AND RENOVATION OF 752 VERNON AVE.

DATE: 21/20
DRAWN BY, JP

4 OF 5

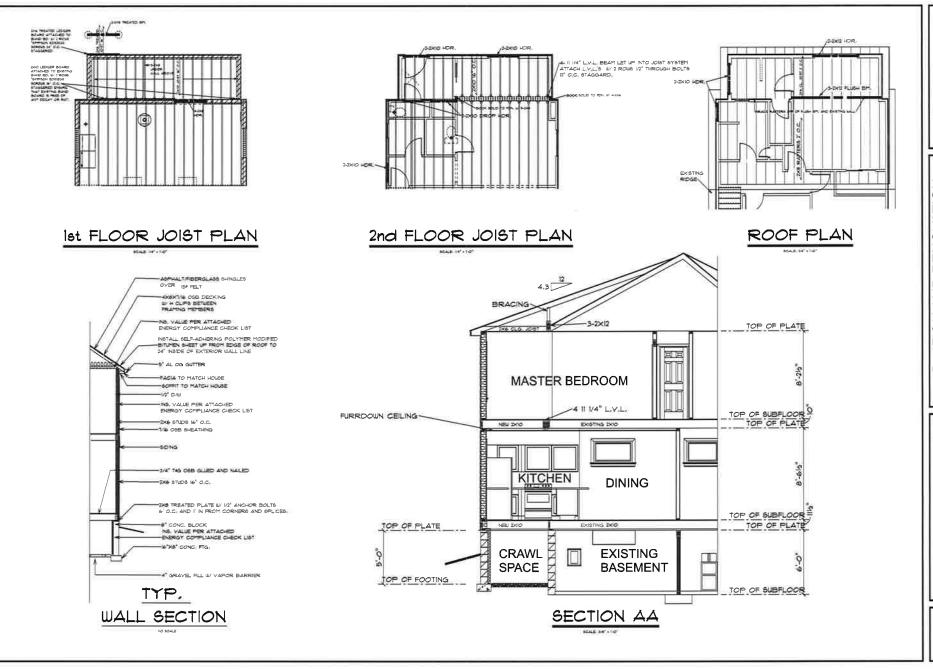

Building

6 minding

6 minding

7 minding

7

ADDITION AND RENOVATION

OF

752 VERNON AVE.


RYTHOR ROWALL
SATE WINDOW THE SATE OF THE


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SHEET







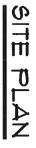

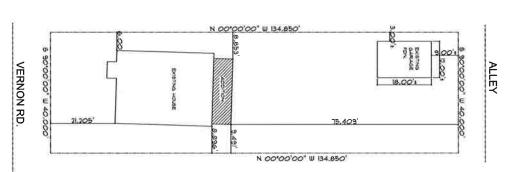

/\	Building	
//BI	service 4	
6 3 6	Associates	
X 3/7	P.O. BOX 77	
	POWELL, OHIO 43065	
	PH 614-841-9460	
	FAX 614-841-9415	
	E-MAIL RESIDENTIALDESIGN@MSN	ĺ.


ADDITION AND RENOVATION


OF

752 VERNON AVE.


BEXLEY, OHIO 43209-2465

DRAWN BY: JP	W
SCALE: NOTED	<del>P</del>
DATE: 2/1/20	W

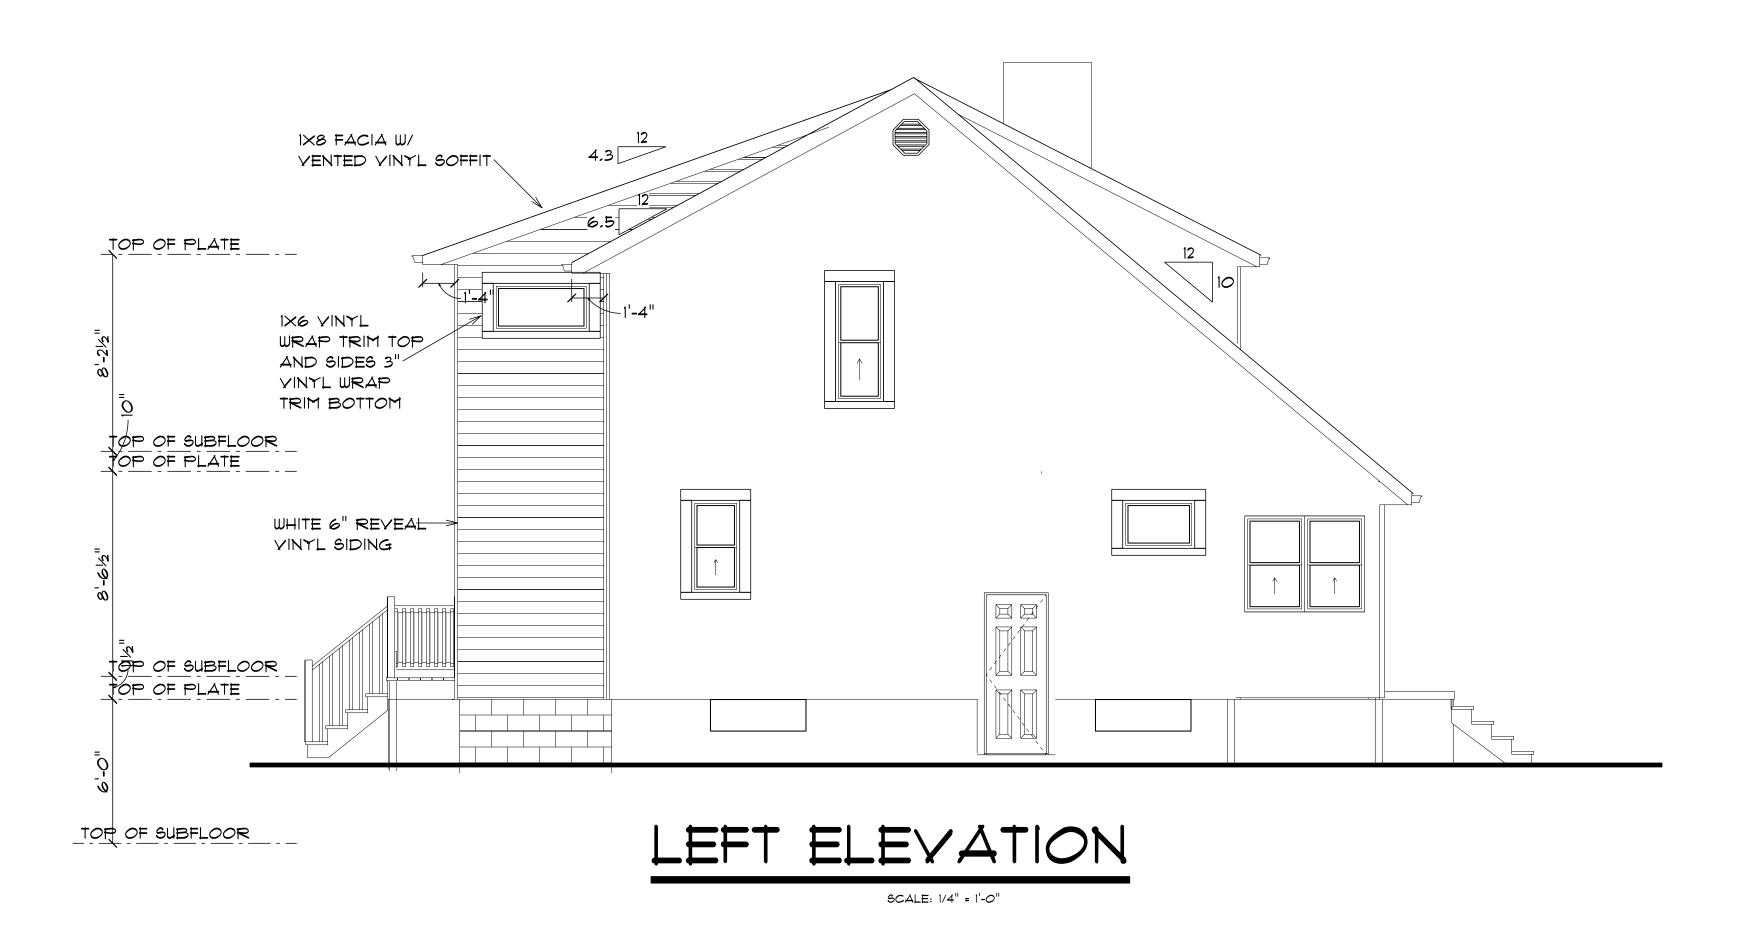


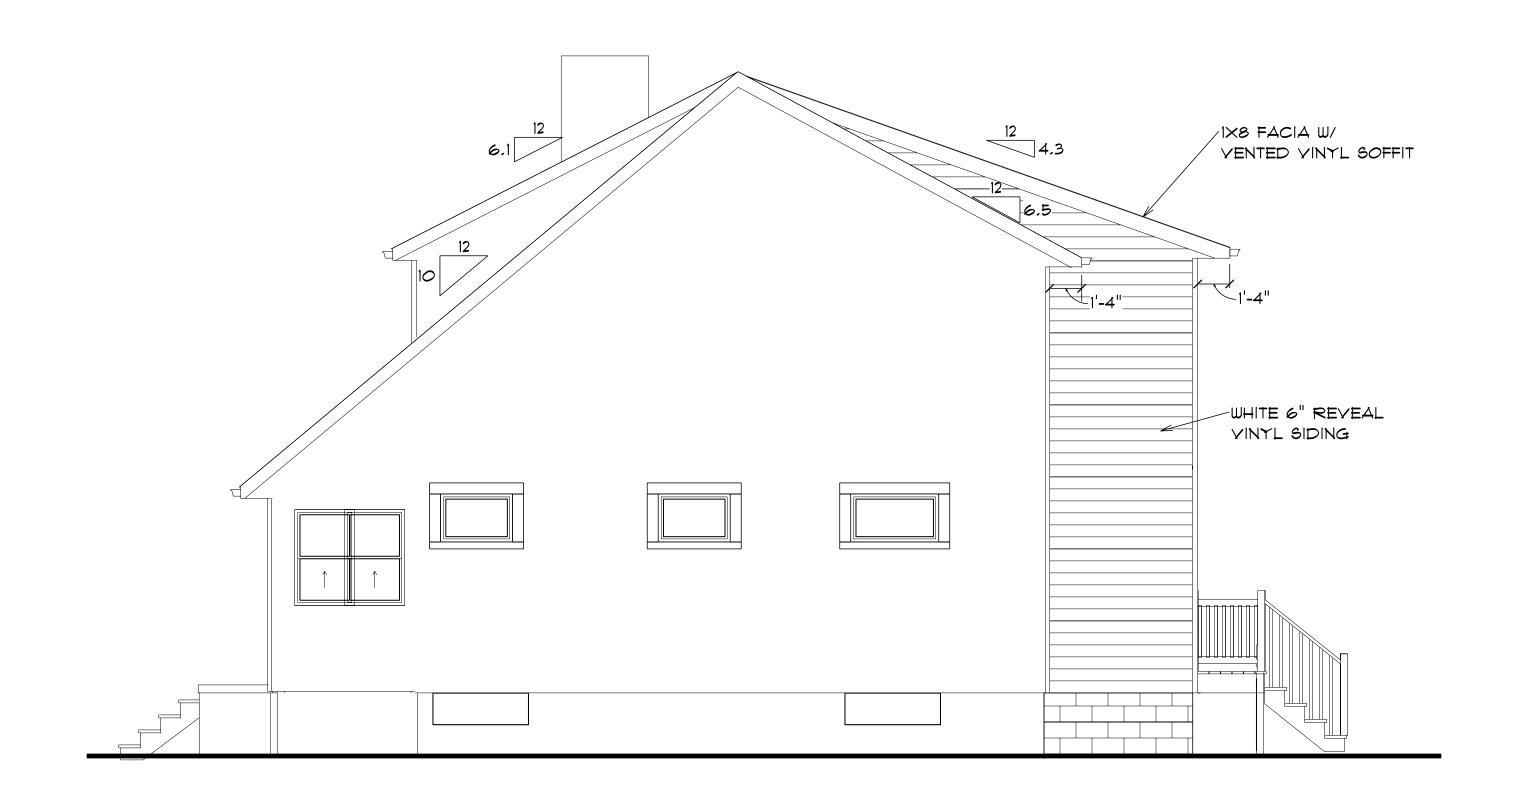


# RIGHT ELEVATION SCALE: 1/4" = 1'-0"

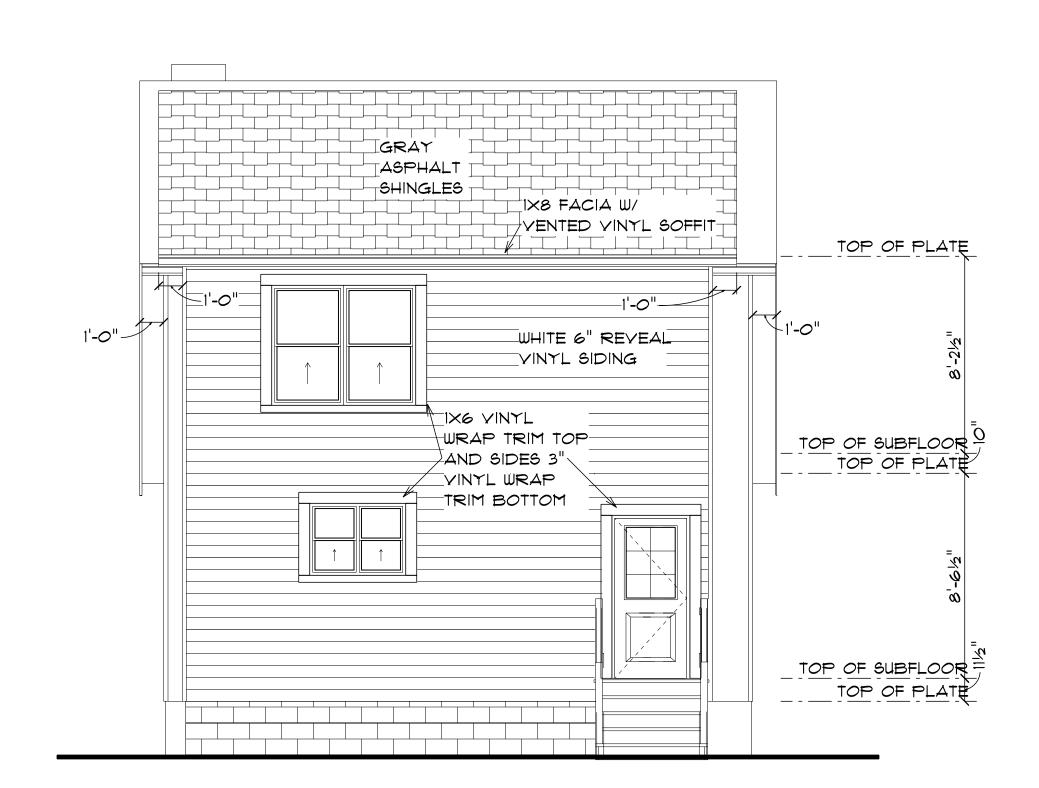

# REAR ELEVATION SCALE: 1/4" = 1'-0"

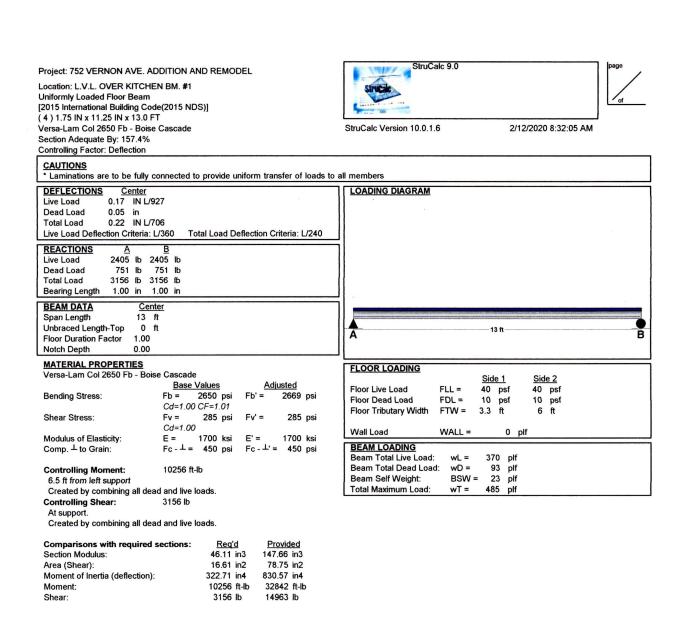

L.Y.L. BM. OYER
KITCHEN DESIGN
CALCULATIONS

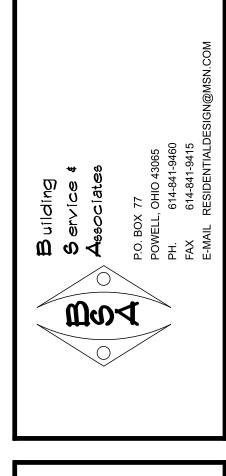

# ADDITION AND RENOVALION OF 752 VERNON AVE.

REVISION SCHEDULE  DATE REVISION NOTE  2/11/20 CONST. DOC.'S  3/10/20 REV. EXT. ELEV. DETAILS
DATE REVISION NOTE 2/11/20 CONST. DOC.'S
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2/11/20 CONST. DOC.'S
3/10/20 REV. EXT. ELEV. DETAILS
DATE: 2/1/20
-
DRAWN BY: JP

4 OF 5

SHEET



# PUBLIC NOTICE CITY OF BEXLEY ARCHITECTURAL REVIEW BOARD BOARD OF ZONING AND PLANNING

The Bexley Architectural Review Board (ARB) will hold a Public Meeting on the following case on <u>Thursday, March 12, 2020 at 6:00 PM</u>, in City Council Chambers, Bexley City Hall, 2242 East Main Street, Bexley, Ohio.

The Bexley Board of Zoning and Planning (BZAP) will hold a Public Hearing on the following case on <u>Thursday, March 26, 2020 at 6:00 PM.</u>, in City Council Chambers, Bexley City Hall, 2242 East main Street, Bexley, Ohio.

The APPLICANT or REPRESENTATIVE must be present at the Public Hearing. The Board may dismiss, without hearing, an application if the applicant or authorized representative is not in attendance. The Board may move to consider the application in those circumstances where dismissal without hearing would constitute a hardship on the adjoining property owners or other interested persons.

a. Application No.: BZAP-20-3Applicant: Brenda Parker

Owner: 2700 Sherwood Rd. LLC Location: 2700 Sherwood Rd.

**ARB Request**: The applicant is seeking architectural review and a recommendation to the Board of Zoning and Planning, to allow a 676 square foot, detached garage that is 22'9" in height, to be constructed in the rear yard.

**BZAP**: The applicant is seeking architectural review and approval to allow a new detached garage. The applicant is also seeking a Special Permit f in accordance with Bexley Code Section 1252.15(e) which states an accessory structure shall not exceed one story in height, ridgeline not to exceed 20' in height without approval from the Board of Zoning and Planning, to allow the proposed detached garage, with 2<sup>nd</sup> floor space, to be 22'9" in height.

A copy of this application is available for review in the Building Department office during the hours of 8:00 A.M. until 4:00 P.M. If you have any questions, please call the Bexley Building Department at 559-4240.

Mailed by: 02-27-2020

Architect: Brenda Parker 614-586-5514



NEW DETACHED GARAGE 2700 SHERWOOD ROAD BEXLEY, OHIO 43209

Permit Set

SCALE:
 As Noted

PROJECT NO.:

DATE:

A2.1

SHEET NO.

Feb 10, 2020



### WINDOW & DOOR SCHEDULE

### 2700 Sherwood Road

New Construction Windows to be Jeldwen V-4500 vinyl windows (with grilles). New Construction Door to be steel: paint in field.

Glass: LoE-272 with Argon. Exterior Color: Almond (verify).

Interior Color: White.

#	NOMENCLATURE	OPERATION	NOTES
(01)	Double (Frame Size 2'-0" x 4'-0")	Double hung	North/South
02	Double (Frame Size 2'-0" x 3'-4")	Double hung	East/West
11)	Swing Door (2'-8" x 6'-8")	Swing Door	6-panel steel Tempered, labeled glass

### **CODED NOTES**

HardiLap siding, smooth, 5" exposure. Paint in field with (1)coat primer + (2)coats high-quality acrylic.

Trim to consist of:

Corner Trim: Smart Trim 3-1/2". Casings: Smart Trim 3-1/2". Frieze Board Trim: 3-1/2".

- 5" aluminum ogee gutter & 3" downspouts on 1x6 aluminum-wrapped wood fascia.
- Soffit to consist of Smart Trim soffit (vented at eaves; solid at gables).
- 4 Roofing: Asphalt shingle, GAF Slateline, color "English Gray".
- Concrete masonry unit foundation wall (buff-colored split face above grade) or cast-in-place concrete foundation wall.
- New overhead sectional garage door 10' wide x 8' height.
  Clopay Coachman Series 1, Design 11, Windows REC14,
  Frosted Glass, Color Sandtone (verify), No Hardware. Provide optional price for Clopay Canyon Ridge (same design as above) in Cypress Walnut Finish.
- HardiShingle siding, smooth, staggered edge. Paint in field with (1)coat primer + (2)coats high-quality acrylic.

Trim to consist of

Corner Trim: Smart Trim 3-1/2".

Casings: Smart Trim 3-1/2".

Frieze Board Trim: 3-1/2".

- 8 Custom overhang with standing seam metal roofing; paint all. Smart Trim soffit at ceiling.
- 9 3-Coat stucco system on water-resistant barrier on air barrier (Tyvek) with lathing per stucco manufacturer's installation recommendations.
- Cultured stone (Dutch Quality, Limestone, Ohio Tan); install per manufacturer's installation instructions.
- Standing seam metal roofing (dark bronze).

Architect: Brenda Parker 614-586-5514



NEW DETACHED GARAGE 2700 SHERWOOD ROAD BEXLEY, OHIO 43209

Permit Set

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PROJECT NO.:

SCALE:
As Noted


ELEVATIONS

DATE:

Feb 10, 2020

SHEET NO.

A2.4

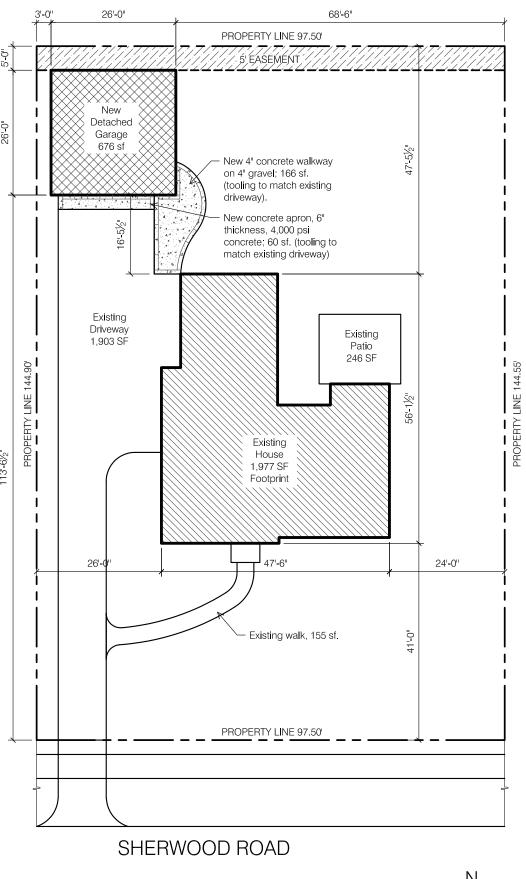

# **OVERALL SITE PLAN**

SCALE: 1" = 20'-0"



### **GENERAL INFORMATION**

2700 Sherwood Road Address: Bexley, Ohio 43209 Parcel:

020-003119-00

Scope of Project: The project consists of the construction of a new 2-car detached garage with second floor storage space.

Footprint New Detached Garage: 676 sf Second Floor Storage Area: 406 sf

### Zoning: Bexley R-6

Lot Area & Lot Width	Actual	Zoning Req't
Lot Area:	14,093 sf	6,000 sf
Lot Width:	97.50'	50'
Lot Depth	145.55'	120'
Building Lot Coverage		
Existing House	1,977 sf	4,932 sf (35%)
New Detached Garage	676 sf	
Total Building Coverage	2,653 sf (19%)	Meets Zoning
Total Lot Coverage		
Total Building Coverage	2,653 sf	8,455 sf (60%)
Driveway	1,903 sf	
Front walk	155 sf	
Existing patio	246 sf	
New apron	60 sf	
New walkway	166 sf	
Total Lot Coverage	5,183 sf (37%)	Meets Zoning
Detached Garage	Actual	Zoning Req't
Garage SF:	676 sf	691 sf (35% of 1,977sf)
Garage Height:	22'-8"	20'-0" (Request Variance)
Garage Rear Setback:	5'-0"	3'-0"
Garage Side Setback:	3'-0"	3'-0"

### SHEET INDEX

A1.0	Site Plan & General Info	A2.4	Garage Elevations
A2.1	Garage Plans	A2.5	Garage Overall Sections
A2.2	Foundation & Roof Plan		
A2.3	Garage Electric Plans		

### **DESIGN CRITERIA**

Design Criteria: Wind Speed = 115 mph Seismic Category = A Weathering = Severe Frost Line Depth = 36" Termite = Moderate to Heavy Ice Barrier Underlayment = Yes, Required. Floor Live Load = 40 psf Snow Load Roof = 20 psf Foundation Concrete Compressive Strength = 2,500 Slab Concrete Compressive Strength = 3,000; air-entrained 5%-7%

Architect: Brenda Parker 614-586-5514




NEW DETACHED GARAGE 2700 SHERWOOD ROAD BEXLEY, OHIO 43209

## Permit Set

SCALE: As Noted PROJECT NO.: DATE: Feb 10, 2020 SHEET NO.

A1.0



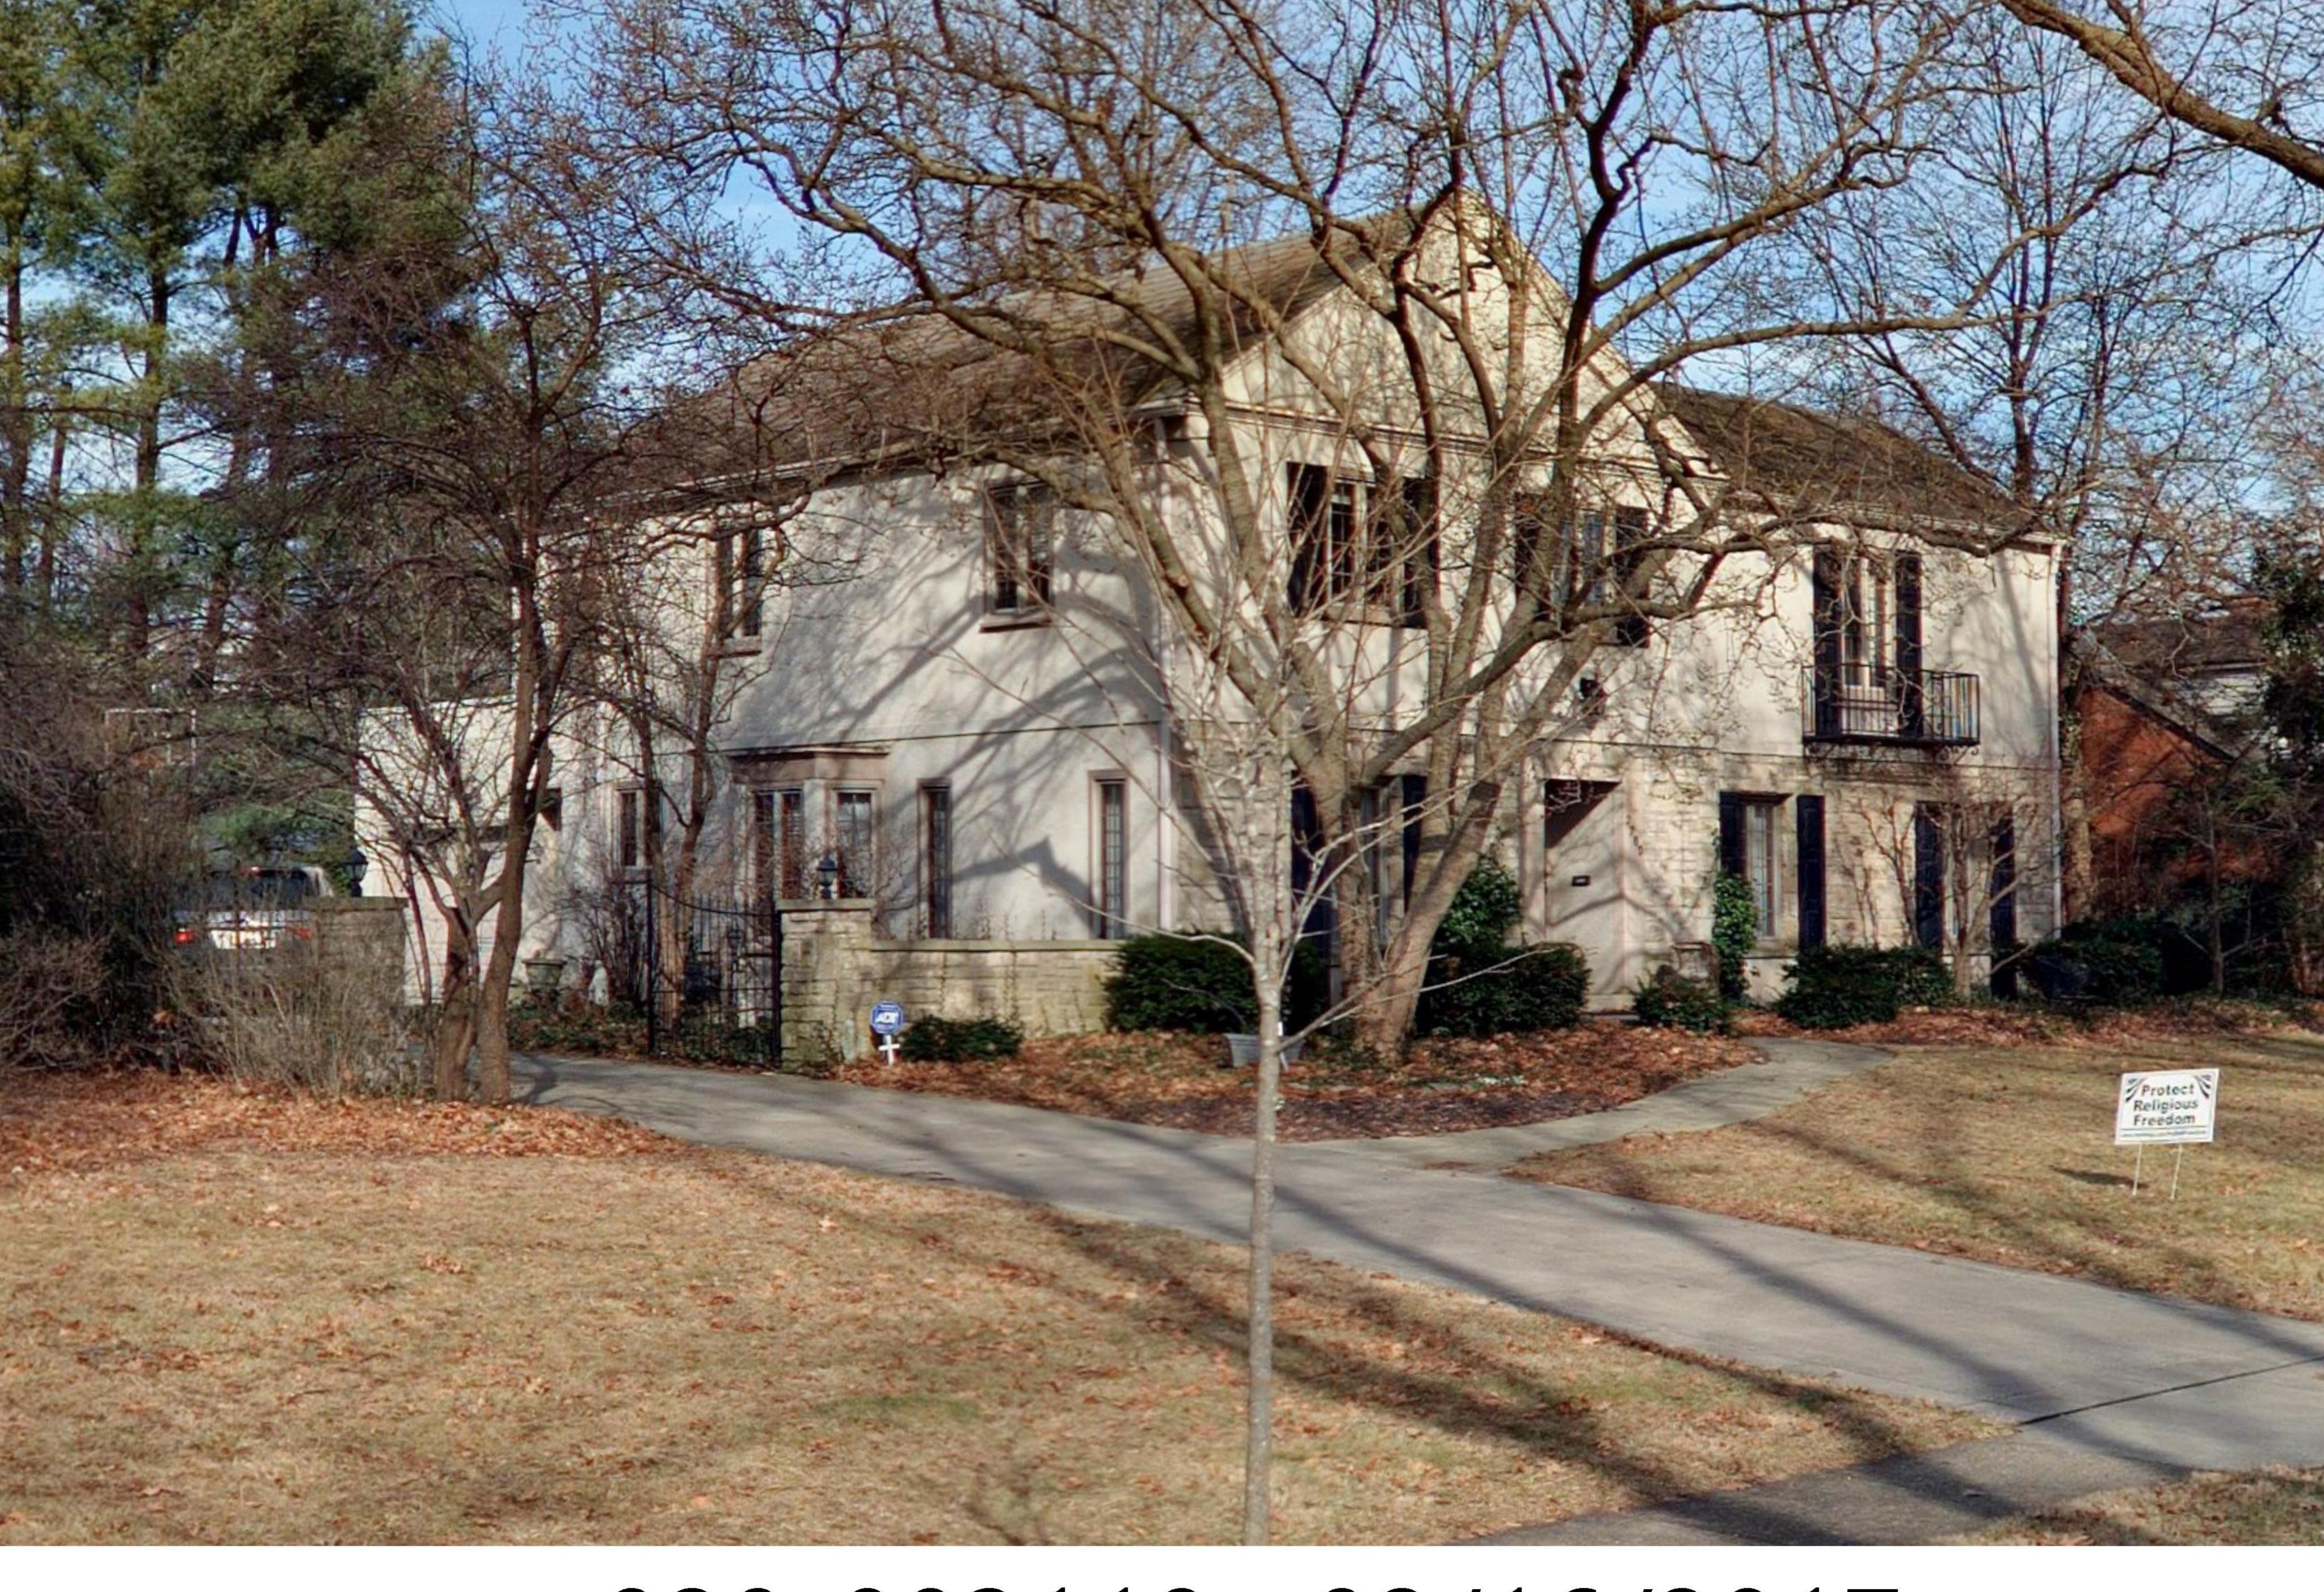

020-003119 02/16/2017