



2 RCP ELECTRIC PLAN SCALE 3/8" = 1'-0"

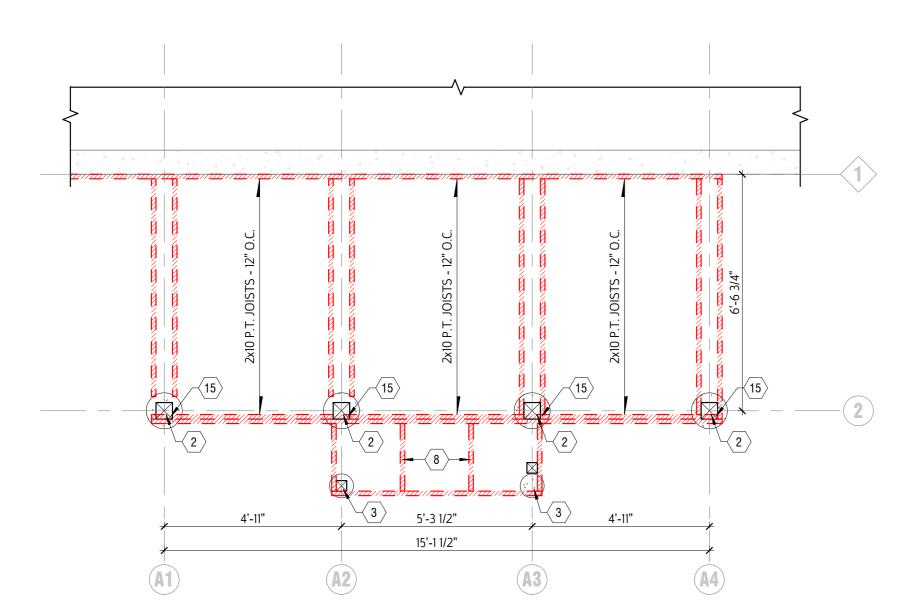

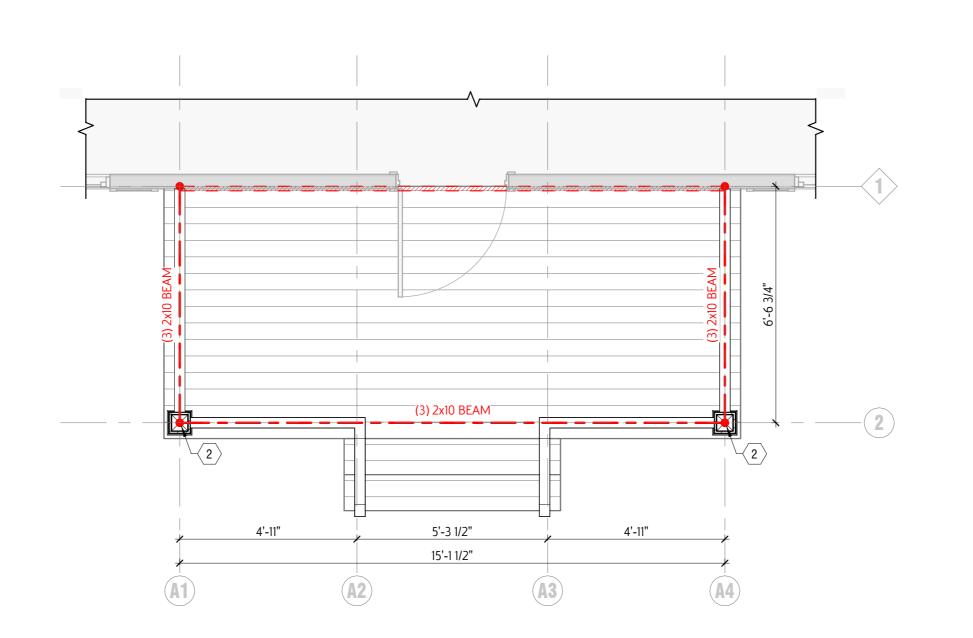





CODED NOTES

- 1 ENGINEERED DECKING TIMBERTECH COMPOSITE IN SEA SALT GRAY FINISH. RUN NORTH/SOUTH.
- 2 6x6 PRESSURE TREATED MOISTURE RESISTANT WOOD POST ON MIN. 12" DIAMETER CONCRETE FOUNDATION EXTENDED BELOW FROST LINE.
- 3 4x4 PRESSURE TREATED MOISTURE RESISTANT WOOD POST ON MIN. 8" DIAMETER CONCRETE FOUNDATION EXTENDED BELOW FROST LINE, PROVIDED FOR MIDSPAN STAIR SUPPORT.
- 4 WRAP STRUCTURE IN CEDAR STAINED WOOD PROVIDE STAINED BASE TRIM.
- 5 1X6 CEDAR PLANK TONGUE AND GROOVE. FINISH WITH CLEAR COAT SEALANT.
- 6 TOP MOUNTED RAILING MIN. 36" HIGH. TREX PRODUCT IN WHITE WITH BLACK SPINDLES.
- 7 BEAM AS SHOWN IN STRUCTURAL PLAN.
- 8 PROVIDE EXTRA STRINGERS ON EXTERIOR PORCH STAIRS.
- 9 BLACK STANDING SEAM METAL ROOF. PROVIDE MIN. 2 LAYERS OF UNDERLAYMENT OR FULL ICE/WATER SHIELD.
- 10 4" EXTERIOR RATED CAN LIGHT
- 11 WALL SCONCE ORIGIN21 "GLEN HOLLOW" LED BLACK
- 12 MISC. TRIM AND SOFFIT IN WHITE VINYL
- 14 BLACK METAL GUTTER
- 15 NOTCH RIM JOIST INTO 6X6 POST. SECURE TO POST WITH MIN. (2) ½" DIAMETE GALVANIZED THRU BOLTS AT POST/JOIST CONNECTION SPACED MIN. 5" APART.
- 16 DEMO EXISTING BRICK PORCH AND ROOF.

GENERAL NOTES

• REFER TO EXPANDED SYMBOL LEGEND FOR ADDITIONAL INFORMATION ON THE INDEX SHEET

EXTERIOR PLAN DIMENSIONS ARE MEASURED TO FACE OF SHEATHING/FACE OF BLOCK/FACE OF CONCRETE/CENTER OF GRID LINE WHERE APPLICABLE

INTERIOR PLAN DIMENSIONS ARE MEASURED TO FACE OF STUD/FACE OF BLOCK/FACE OF CONCRETE/CENTER OF GRID LINE WHERE APPLICABLE

- INTERIOR DOOR OPENINGS NOT LOCATED BY DIMENSION ARE TO BE LOCATED 4 1/2" OFF OF ADJACENT PERPENDICULAR WALL UNLESS OTHERWISE NOTED
- WINDOW AND DOOR OPENING DIMENSIONS W/ "R.O." REPRESENT ROUGH OPENINGS. MANUFACTURER TO ACCOUNT FOR SHIM SPACE.
- WINDOW AND DOOR OPENING DIMENSIONS ARE TO THE OUSIDE OF OPENING. REFER TO CUT SHEETS FOR ROUGH OPENINGS. MANUFACTURER TO ACCOUNT FOR SHIM

PROVIDE ALL REQUIRED BLOCKING, FURRING, AND BACK FOR ANY WALL-MOUNTED FIXTURES, SHELVING AND ACCESSORIES.

CONTRACTORS SHALL COORDINATE THE SIZE AND LOCATION OF ALL NEW M.E.P. ITEMS OR OPENINGS w/THE APPROPRIATE CONTRACTOR


PLUMBING FIXTURES, SINKS, ELECTRIC WATER COOLERS, WATER CLOSETS, URINALS, ETC. ARE TO BE CENTERED w/CABINETS, PARTITIONS, AND FRAMED OPENINGS, U.N.O. ON ENLARGED PLANS / ELEVATIONS

PLAN LEGEND

 NOT ALL PLAN SYMBOLS MAY BE USED ON EACH SHEET EXISTING WALL ASSEMBLY ASSEMBLY SHEAR WALL DEMOLISHED REFER TO WALL ASSEMBLY STRUCTURE /ELEMENT INDICATES TYPE A **UNIT IS BEING** ILLUSTRATED EXISTING DOOR



NUMBER "#" -# REFER TO DOOR

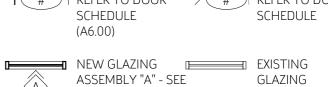

ASSEMBLY "A" - SEE GLAZING ASSEMBLY ELEVATIONS INDICATES COLUMN LINE

CODE DATA 2019 OHIO RESIDENTIAL CODE

DESIGN LIVE LOADS

25 PSF (GROUND SNOW) CEILING JOISTS (HIGH SLOPE) 20 PSF
CEILING JOISTS (LOW SLOPE) 10 PSF
FLOORS/STAIRS/DECKS 40 PSF

Bexley

□ 9/25/2025

025012



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PLAN LEGEND NOT ALL PLAN SYMBOLS MAY BE USED ON EACH SHEET

EXISTING WALL ASSEMBLY → ASSEMBLY SHEAR WALL DEMOLISHED WALL ASSEMBLY REFER TO /ELEMENT STRUCTURE INDICATES TYPE A

UNIT IS BEING ILLUSTRATED NEW DOOR NUMBER "#" -# REFER TO DOOR # REFER TO DOOR SCHEDULE (A6.00)

NEW GLAZING EXISTING ASSEMBLY "A" - SEE GLAZING GLAZING ASSEMBLY **ELEVATIONS**

EXISTING DOOR

NUMBER "#" -


SCHEDULE


INDICATES COLUMN LINE

CODE DATA

2019 OHIO RESIDENTIAL CODE DESIGN LIVE LOADS

ROOF 25 PSF (GI CEILING JOISTS (HIGH SLOPE) 20 PSF CEILING JOISTS (LOW SLOPE) 10 PSF FLOORS/STAIRS/DECKS 40 PSF 25 PSF (GROUND SNOW)

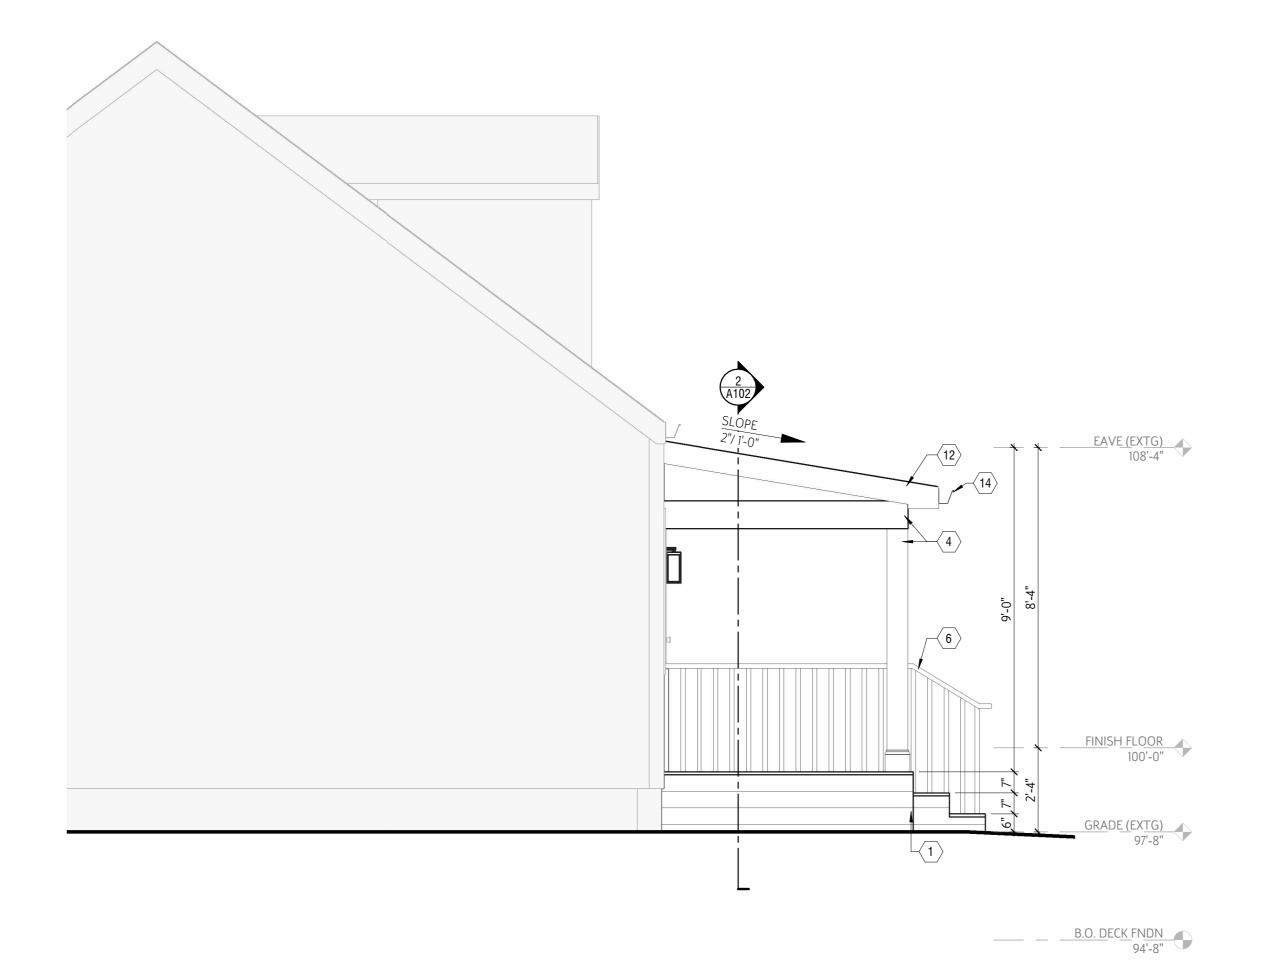

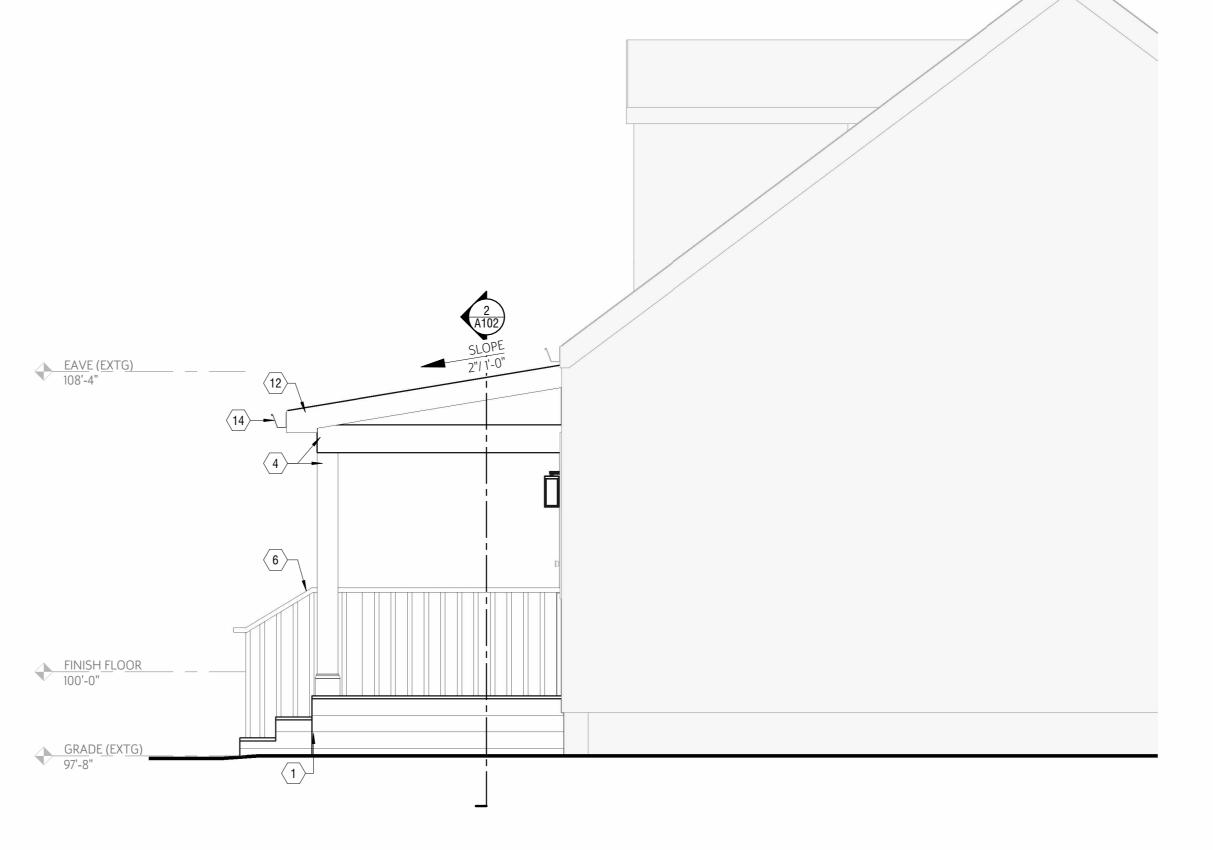

2 ELEVATION - NORTH
SCALE 3/8" = 1'-0"

3 ELEVATION - SOUTH
SCALE 3/8" = 1'-0"

Bexley FINAL COORDINATION 9/25/2025 025012 SHEET TITLE ELEVATIONS



FRONT PERSPECTIVE RENDER

