


LAYOUT LEGEND

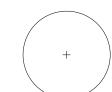

EXISTING TREE, TYP. REFER TO L2.0 FOR TREE REMOVAL AND PRESERVATION PLAN



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Project Name

Bexley Family Housing

420 N Cassady Ave. Bexley, Ohio

Prepared For

The Community Builders 736 Oak Street Columbus, Ohio 43205




24072 2/13/2025 GM, AC As Shown

Revisions

Sheet Title EXISTING CONDITIONS PLAN

Sheet #

LO.1

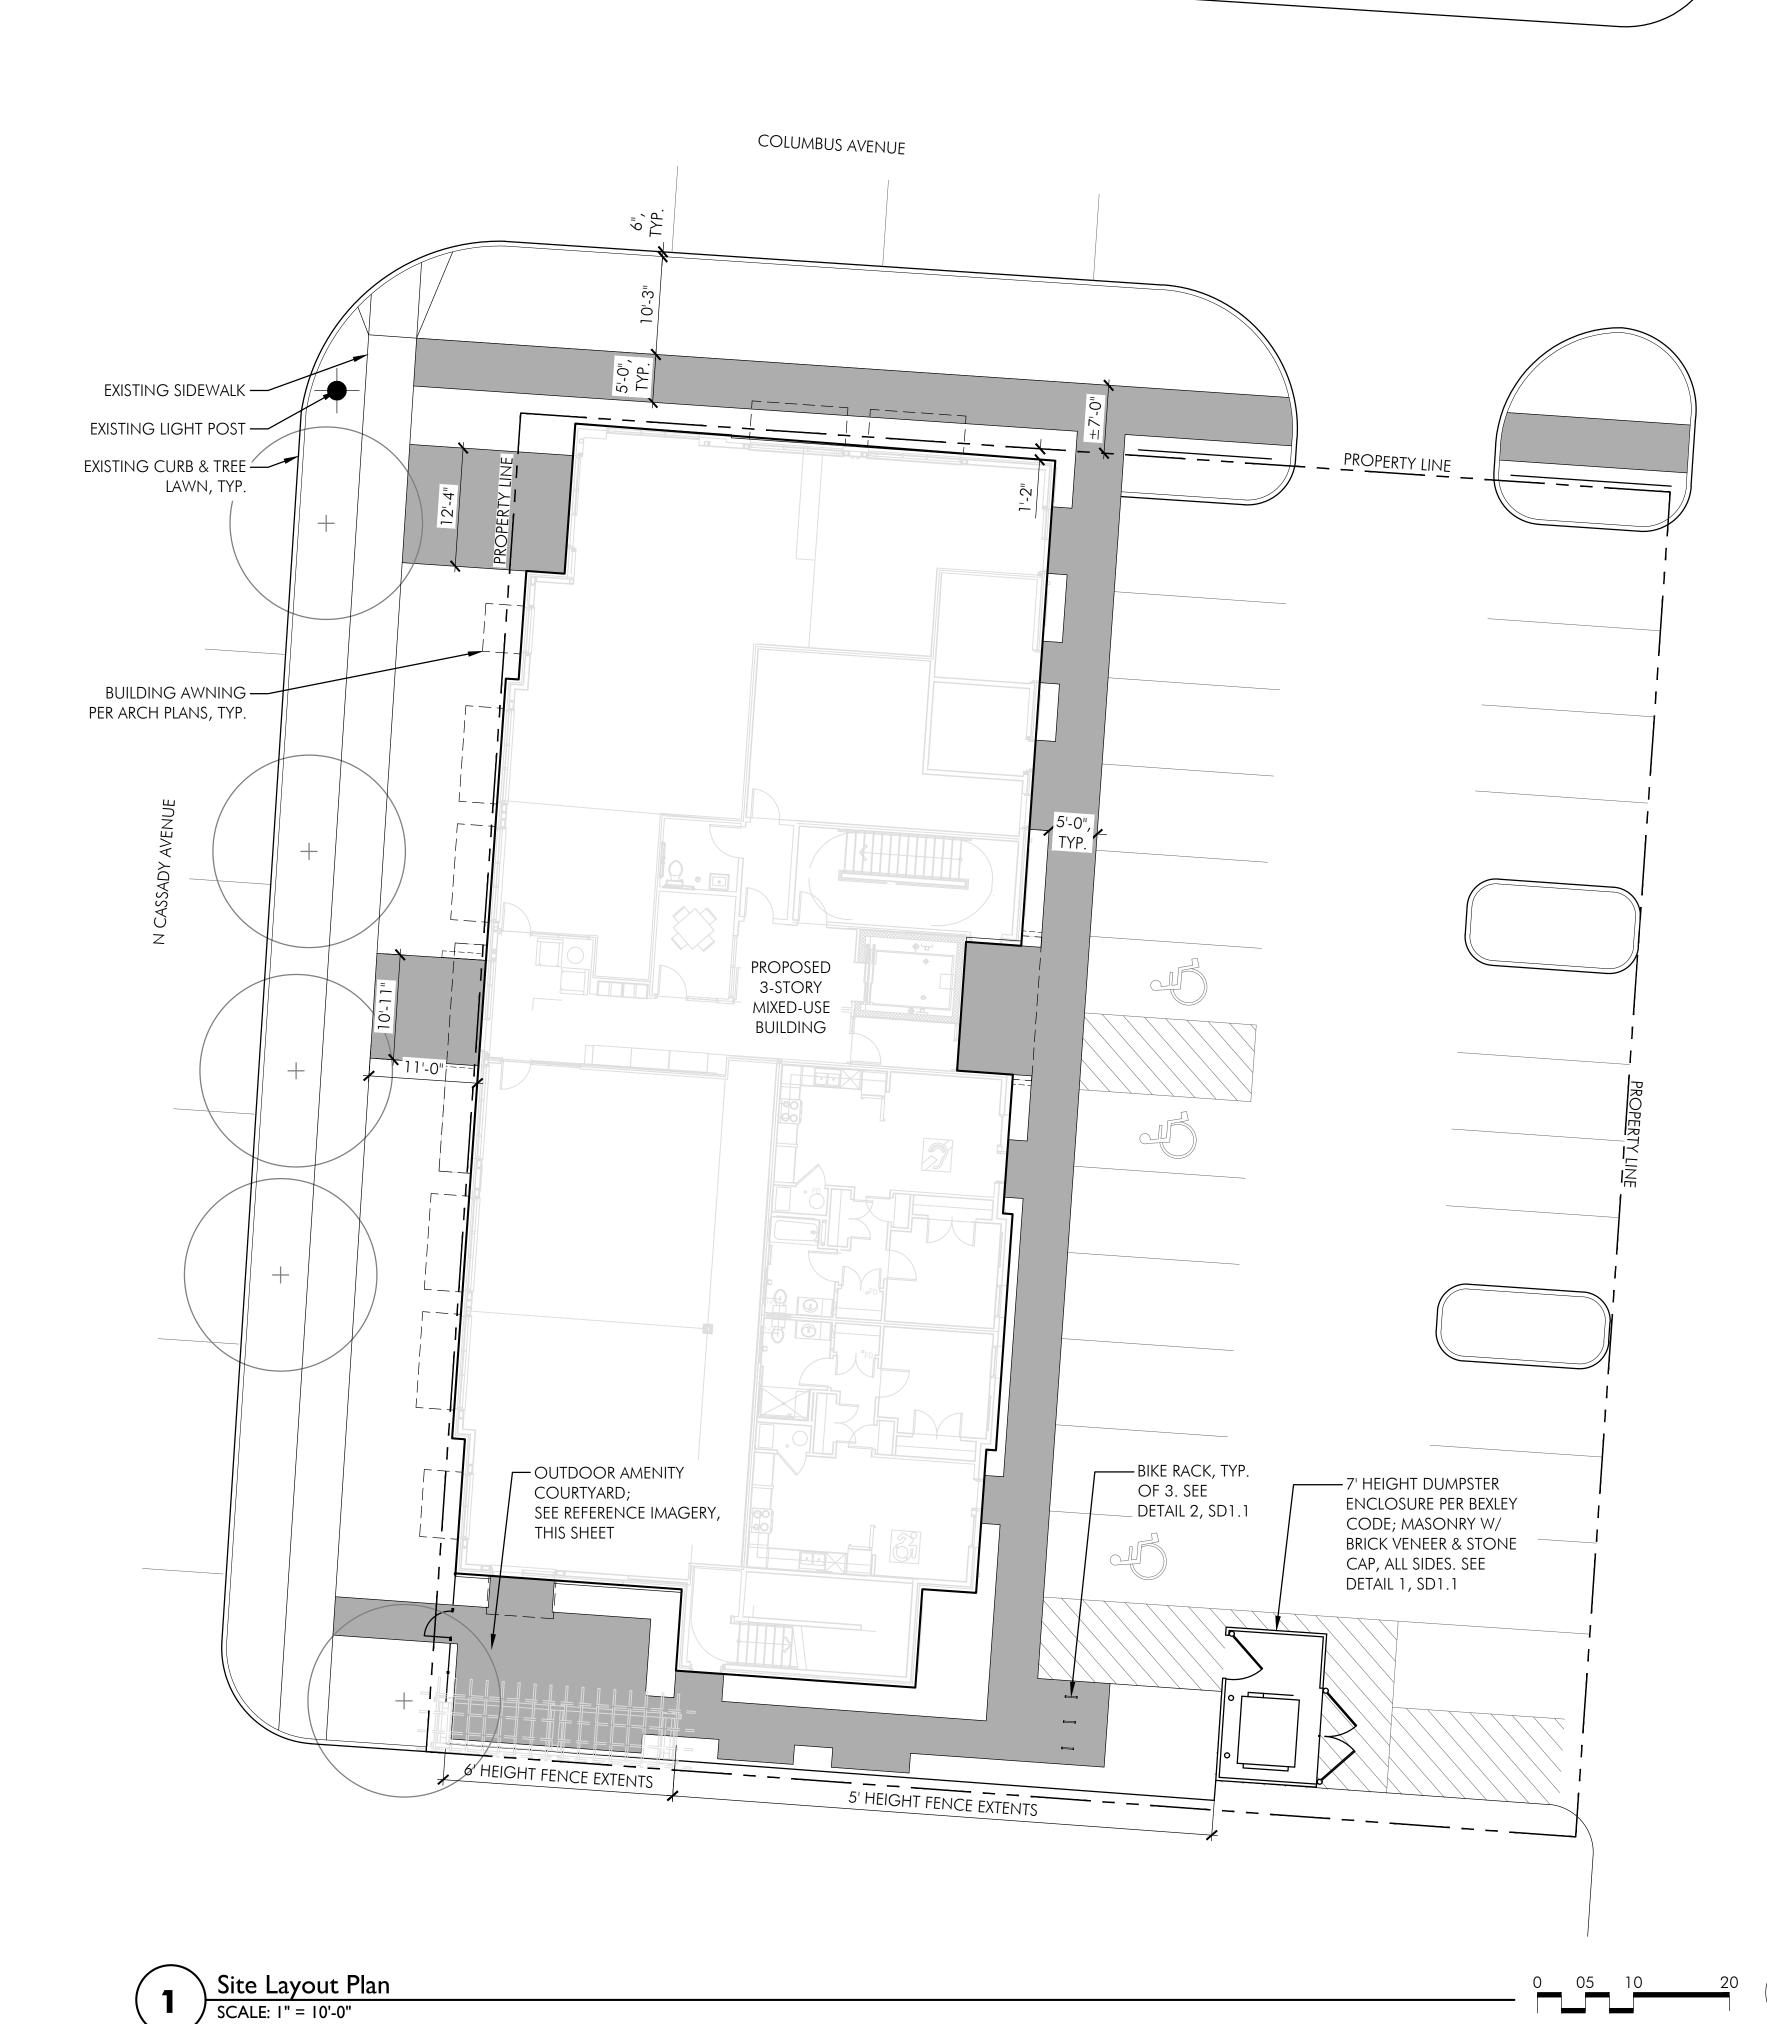

LAYOUT LEGEND

₩ 0'-0" LINEAR DIMENSION

BROOM-FINISH CONCRETE PAVING

EXISTING LIGHT POLE TO REMAIN

ZONING REQUIREMENTS

1254.11 - MIXED USE COMMERCIAL (MUC) DESIGN STANDARDS

w. Dumpsters shall be located behind the principal building and be screened from public view on all 4 sides, to the height of the dumpster

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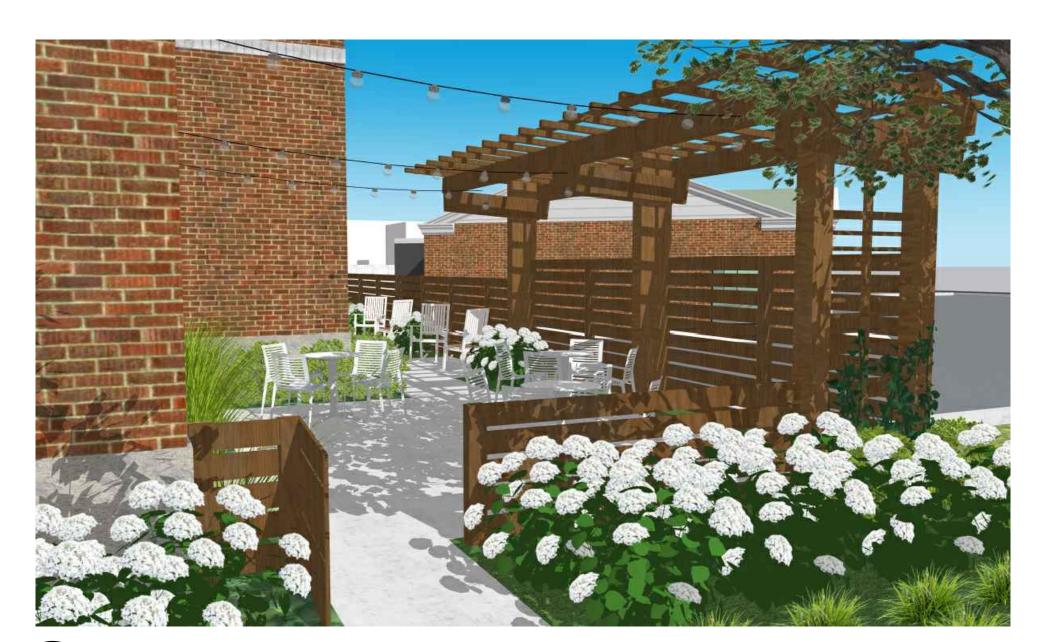
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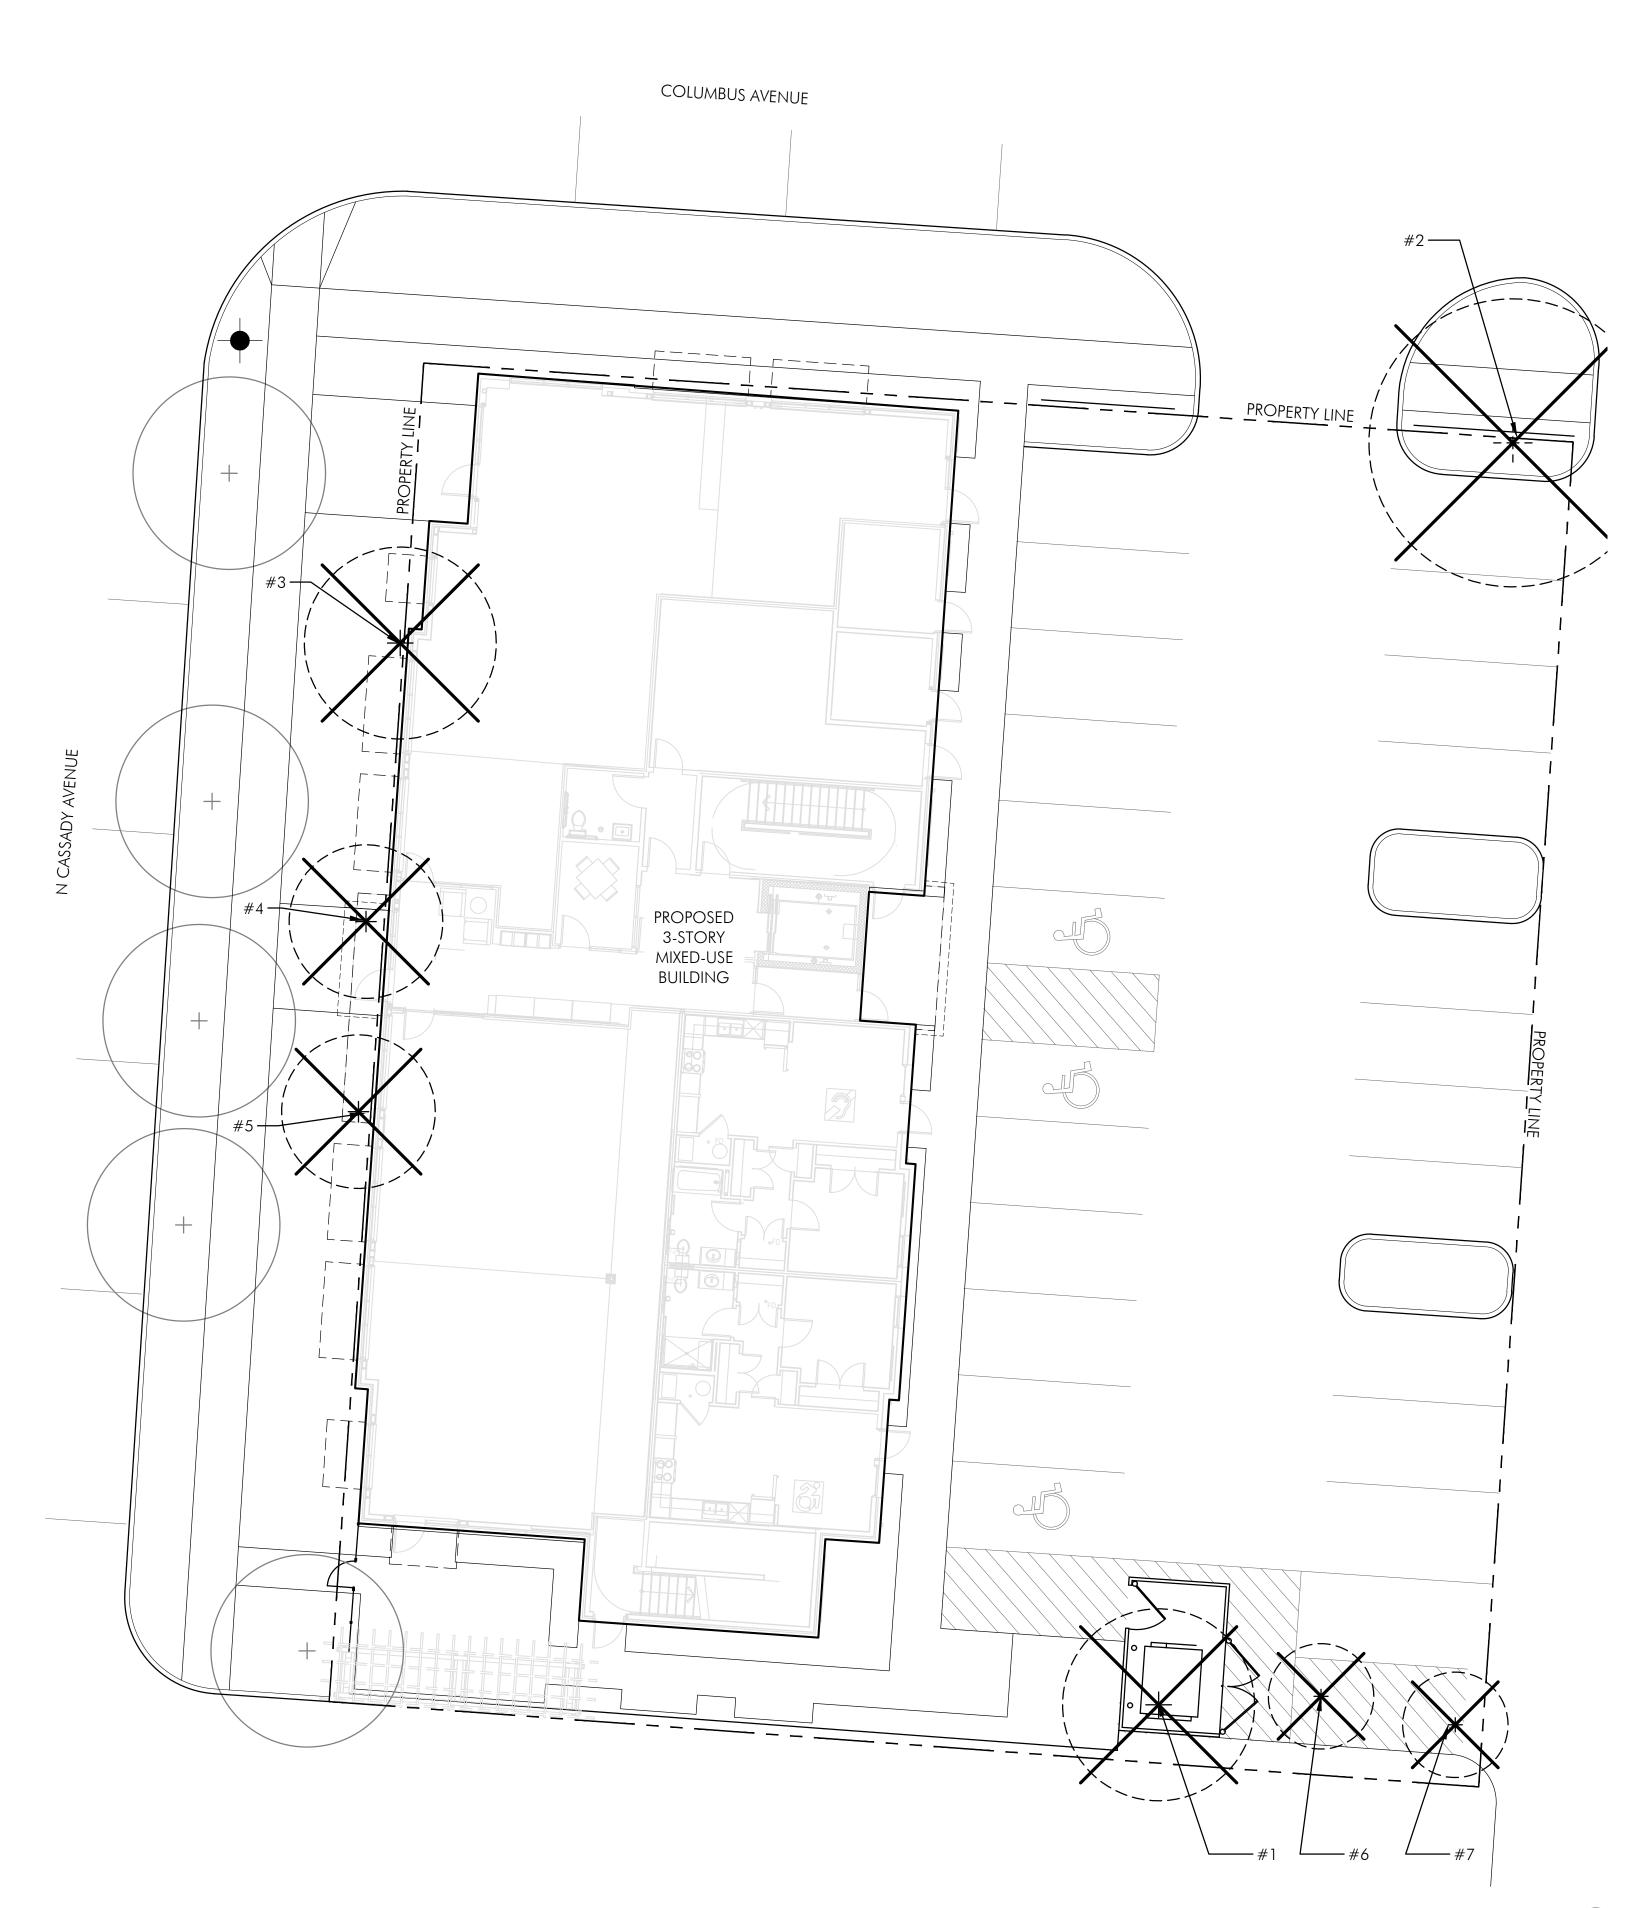
Sheet Title SITE LAYOUT **PLAN**

Sheet #

L1.0




Outdoor Amenity Courtyard Imagery
SHOWN FOR REFERENCE ONLY (NOT TO SCALE)



LEGEND

—— — — PROPERTY LINE

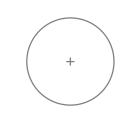

EXISTING TREE TO REMAIN AND BE PROTECTED IN PLACE -SEE DETAIL, SHEET SD1.0



EXISTING TREE TO BE REMOVED

TREES REMOVED CALCULATIONS

86 TOTAL INCHES TO BE REMOVED (5 TREES)

58 CALIPER INCHES OF TREES WHICH ARE TO BE REMOVED DUE TO THE POOR, DEAD, OR EXEMPT CONDITIONS.

28 CALIPER INCHES OF TREES WHICH ARE TO BE REMOVED ARE IN FAIR TO GOOD

TOTAL INCHES PROVIDED (SEE SHEET L2.1):

17 LARGE DECIDUOUS TREES @ 3" CAL. = 51 CALIPER INCHES 2 ORNAMENTAL OR COLUMNAR TREES @ 2" CAL. PER STEM = 4 CALIPER INCHES

TREE PRESERVATION, REMOVAL, & REPLACEMENT NOTES

- 1. TREE HEALTH EVALUATION IS PRELIMINARY. FINAL EXAMINATION OF TREE HEALTH AND SPECIES TO BE PREFORMED BY CERTIFIED ARBORIST / CITY OF BEXLEY FORESTER.
- 2. ALL TREES IN THE CONSTRUCTION AREA NOT SPECIFICALLY DESIGNATED FOR REMOVAL SHALL BE PRESERVED. ALL TREE REMOVAL AND PRESERVATION WORK SHALL BE SUPERVISED WITH THE INPUT OF A CERTIFIED ARBORIST.
- 3. FENCING SHALL BE INSTALLED AROUND ALL TREES TO BE PRESERVED PRIOR TO THE COMMENCEMENT OF CONSTRUCTION. THE FENCING MUST REMAIN IN PLACE DURING ALL PHASES OF CONSTRUCTION. ANY CHANGES IN THE PROTECTIVE FENCING MUST BE APPROVED BY THE LANDSCAPE INSPECTOR. OWNER SHALL BE RESPONSIBLE FOR THE CONSTRUCTION, ERECTION, AND MAINTENANCE OF PROTECTION FENCING; REFER TO TREE PRESERVATION DETAIL.
- 4. PRESERVED TREES REMAINING ARE TO BE FERTILIZED AND PRUNED (IF NEEDED) TWO YEARS AFTER CONSTRUCTION.
- 5. OWNER SHALL MONITOR HEALTH AND VIGOR OF EXISTING TREES THROUGHOUT THE COURSE OF CONSTRUCTION OF THIS PROJECT. CONTRACTOR TO NOTIFY A CERTIFIED ARBORIST IF ANY DECLINE IN HEALTHY TREES IS APPARENT. THE ARBORIST SHALL DETERMINE THE REMEDIAL ACTION, IF ANY, TO BE TAKEN.
- 6. ALL EXISTING TREES NOTED AS FAIR TO POOR HEALTH SHALL BE FERTILIZED YEARLY IN THE SPRING USING A HORTICULTURALLY APPROVED METHOD FOR A PERIOD OF THREE YEARS. AFTER THREE YEARS, THE HEALTH OF THE TREE SHOULD BE EVALUATED BY A CERTIFIED ARBORIST AND CONTINUING MAINTENANCE RECOMMENDATIONS SHALL BE
- 7. ANY TREES REMOVED OR DAMAGED IN TREE PRESERVATION WILL HAVE TO BE REPLACED PER CODE.
- 8. FAILURE TO ABIDE BY THESE TERMS OF THE TREE PRESERVATION, REMOVAL, AND REPLACEMENT SHALL BE UNLAWFUL.

EXISTING TREE IMAGES TO BE REMOVED




#1: ACER RUBRUM CALIPER INCHES: 23" CONDITION: POOR #4: TSUGA CANADENSIS CALIPER INCHES: 6" CONDITION: DEAD

#3: FRAXINUS AMERICANA CALIPER INCHES: 4" CONDITION: POOR



#2: ACER RUBRUM, RED MAPLE CALIPER INCHES: 25" CONDITION: POOR

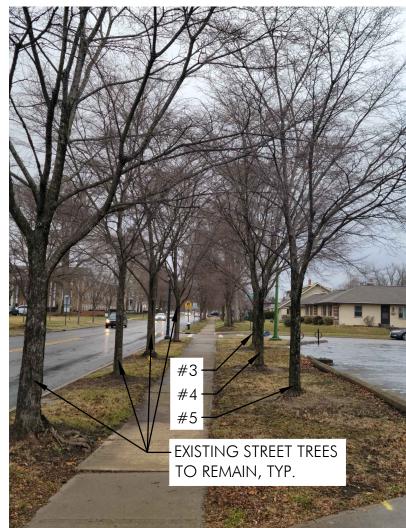

#3-5: ULMUS 'FRONTIER' CALIPER INCHES: #3: 10", #4:10", #5: 8" CONDITION: GOOD

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Prepared For

The Community Builders 736 Oak Street Columbus, Ohio 43205



Project Info

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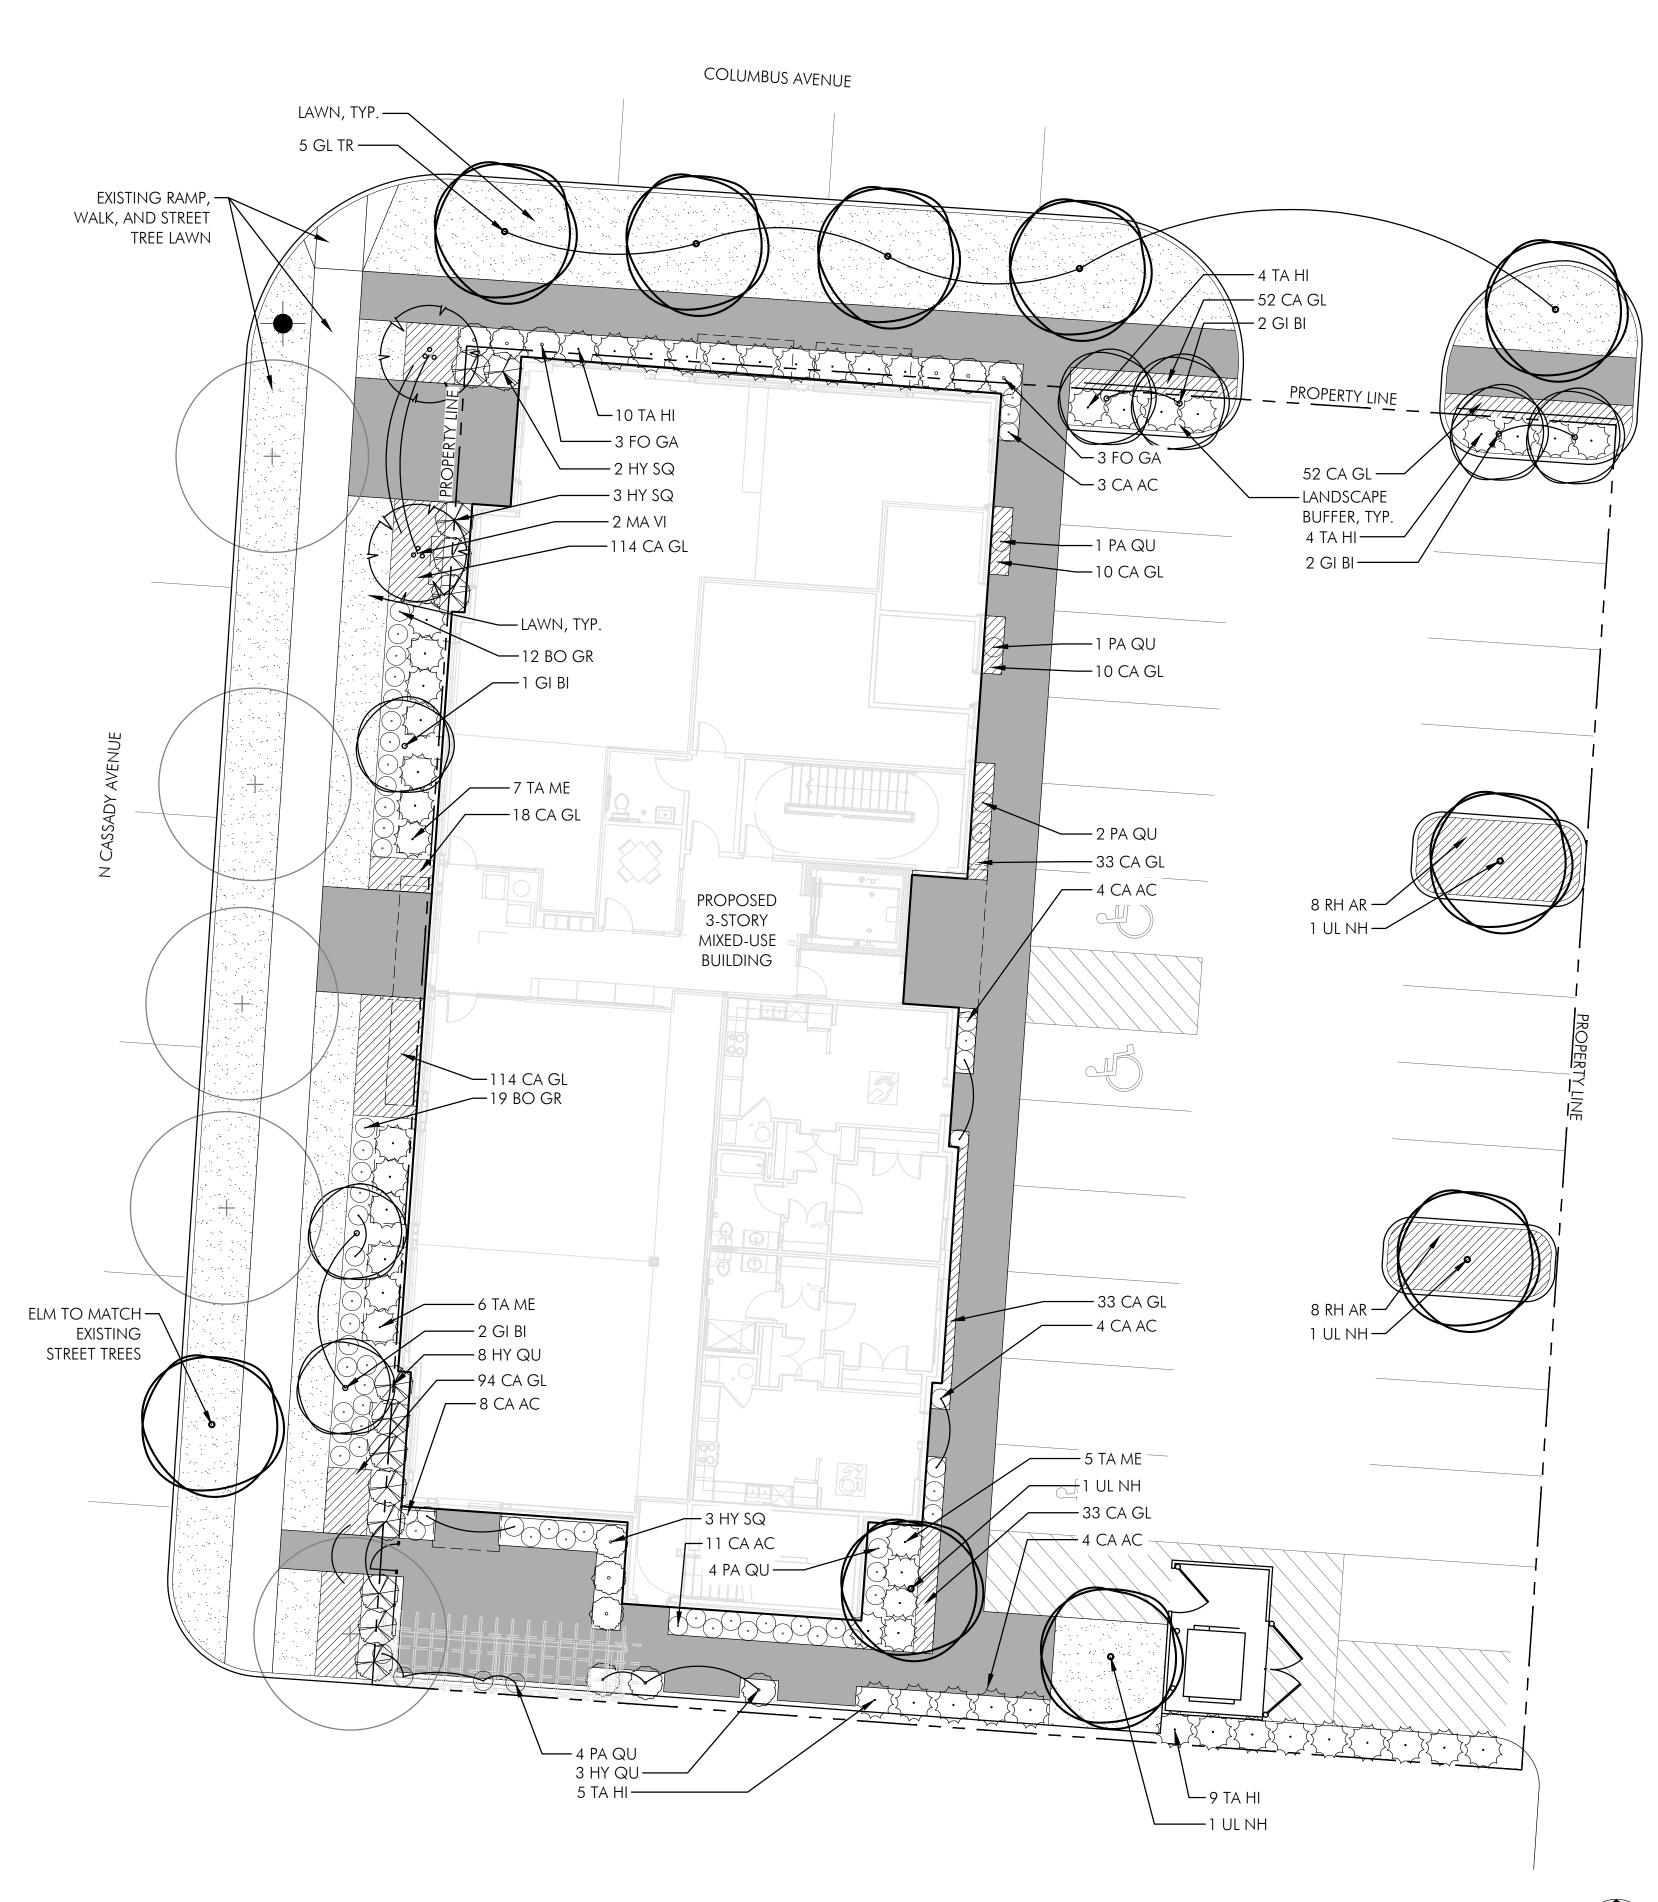
Revisions

Sheet Title TREE REMOVAL

AND PRESERVATION PLAN

Sheet #

L2.0



Landscape Plan
SCALE: I" = 10'-0"



ZONING REQUIREMENTS

1254.11 - MIXED USE COMMERCIAL (MUC) DESIGN STANDARDS Landscaping and Screening

o. The front yard shall be planted with live vegetation and a shade tree(s) (in addition to any street tree requirements), except for paved areas expressly designed for vehicular and pedestrian use. The minimum number of shade trees required is determined by the formula of one tree per 30 lineal feet, or fraction thereof, of frontage.

Columbus Ave: 77 linear feet of frontage = 3 shade trees required 5 shade trees provided

N Cassady Ave: 125 linear feet of frontage = 5 shade trees required

(4 existing)

5 shade trees provided

q. All street tree planting beds must have a minimum exposed space of 60 square feet.

u. surface parking lot or vehicular circulation area shall be screened from all abutting public streets with a minimum 4-foot solid masonry or stone wall; or a minimum 4-foot decorative metal tube or solid metal bar fence (excluding chain link, wire mesh or other similar material), with a minimum 3-foot wide landscaped area along the parking lot side of the fence.

v. Landscaping is needed for surface parking lots in order to further screen parking from the view of public rights-of-way, provide mitigation for stormwater through reducing, slowing and cooling runoff, and to create visual relief from large pavement areas. This landscaping might be in well-designed border plantings that frame the lot or within landscape beds large enough to sustain successful plant growth.

LEGEND


—— — — PROPERTY LINE



BROOM FINISH CONCRETE PAVING



LAWN

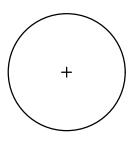

existing tree to remain

NOTES:

1. REFER TO SHEET L2.2 FOR CONCEPTUAL PLANT PALETTE

QTY.	SYMBOL	BOTANICAL & COMMON NAMES	SIZE	COND.	REMARKS
DECID	UOUS TREES				
	GI BI	Ginkgo biloba Princeton Sentry Ginkgo	3" Cal.	B&B	as shown
	GL TR	Gleditsa triacanthos var. inermis "Sky Cole" Skyline Honeylocust	3" Cal.	B&B	as shown
	UL NH	Ulmus 'New Horizon' New Horizon Elm	3" Cal.	B&B	as shown
ORNA	mental tree	ES	•	•	
	MA VI	Magnolia virginiana Sweetbay Magnolia	12' ht.	B&B	(3)Multi-stem 2" cal./stem
SHRUB	SS				
	FO GA	Fothergilla gardenii Dwarf Fothergilla	24" ht.	#3 cont.	AS SHOWN
	HY QU	Hydrangea quercifolia Munchkin Oakleaf Hydrangea	24" ht.	#5 cont.	as shown
	HY SQ	Hydrangea quercifolia Snowqueen Oakleaf Hydrangea	24" ht.	#5 cont.	as shown
	RH AR	Rhus aromatica 'Gro-Low' Fro-Low Fragrant Sumac	24" ht.	#3 cont.	36" O.C.
	TA ME	Taxus x media 'Everlow' Everlow Yew	24" ht.	#3 cont.	as shown
	TA HI	Taxus x media 'Hicksii' Hicksii Yew	24" ht.	#5 cont.	as shown
PEREN	nials/ orna	AMENTAL GRASSES/ GROUNDCOVERS			
	BO GR	Bouteloua gracilis 'Blonde Ambition' Blonde Ambition Blue Grama Grass	Clump	#1 cont.	as shown
	CA AC	Calamagrostis x acutiflora 'Karl Foerster' Karl Foerester Reed Grass	Clump	#1 cont.	as shown
	CA GL	Carex glauca Blue Sedge	Clump	#1 cont.	10" o.c.
	PA QU	Parthenocissus quinquefolia Virginia Creeper	Clump	#1 cont.	AS SHOWN



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420 N Cassady Ave. Bexley, Ohio

Prepared For

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Project Info

Project # 24072
Date 2/13/2025
By GM, AC
Scale As Shown

Revisions

LANDSCAPE PLAN

Sheet #

L2.1

Deciduous Shade Trees



Gleditsa triacanthos var. inermis 'Sky Cole' Skyline Honeylocust



New Horizon Elm



Ginkgo biloba 'Princeton Sentry' Princetone Sentry Ginkgo



Ornamental Trees

Magnolia virginiana Sweetbay Magnolia

Evergreen Shrubs



Hicks Yew



Everlow Yew

Deciduous Shrubs



Hydrangea quercifolia 'Munchkin' Munchkin Oakleaf Hydrangea



Hydrangea quercifolia 'Snow Queen' Snow Queen Oakleaf Hydrangea



Fothergilla gardenii Dwarf Fothergilla



Rhus Aromatica 'Gro-Low' Gro-Low Fragrant Sumac

Perennials, Grasses, and Groundcover



Carex glauca Blue Sedge



Bouteloua gracilis 'Blonde Ambition' Blonde Ambition Blue Grama Grass



Calamagrostis x acutitlora 'Karl Foerster' Karl Foerester Reed Grass



Parthenocissus quinquefolia Virginia Creeper



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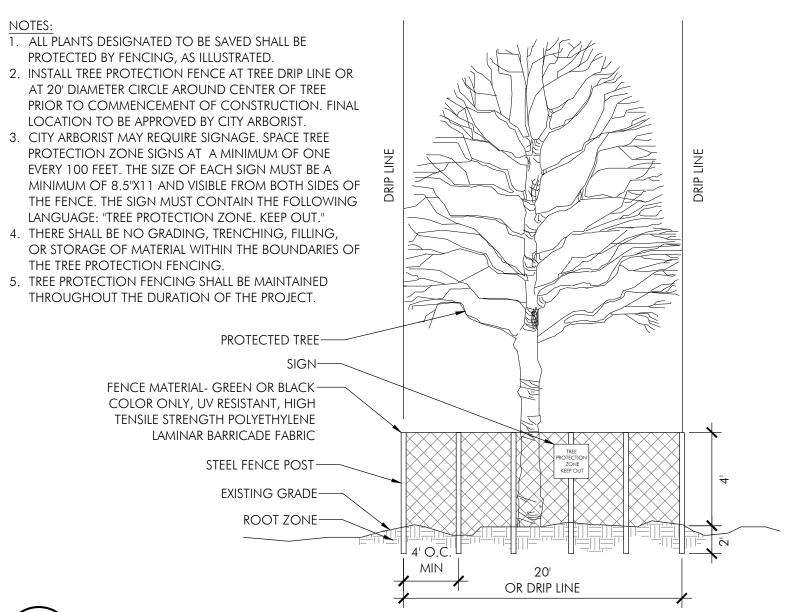
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Sheet Title PLANT PALETTE IMAGERY

Sheet #

L2.2




Tree Preservation

THE AMOUNT OF PRUNING SHALL BE LIMITED TO 1/3 OF THE BRANCHES TO COMPENSATE FOR LOSS OF ROOTS FROM TRANSPLANTING. REMOVE DEAD AND INJURED LIMBS. REMOVE BURLAP AND WIRE OR TWINE FROM TOP AND SIDES OF BALL. CENTER SHRUB IN HOLE. SET TOP OF BALL 1-3" ABOVE FINISH GRADE.

1. DO NOT PRUNE SHRUBS DURING INSTALLATION

- 2. MEASURE ROOTBALL AND SET 1" HIGHER ON HARD PEDESTAL, DO NOT DISTURB AREA UNDERNEATH ROOTBALL
- 3. SEE PLANTING NOTES FOR MULCH TYPE AND

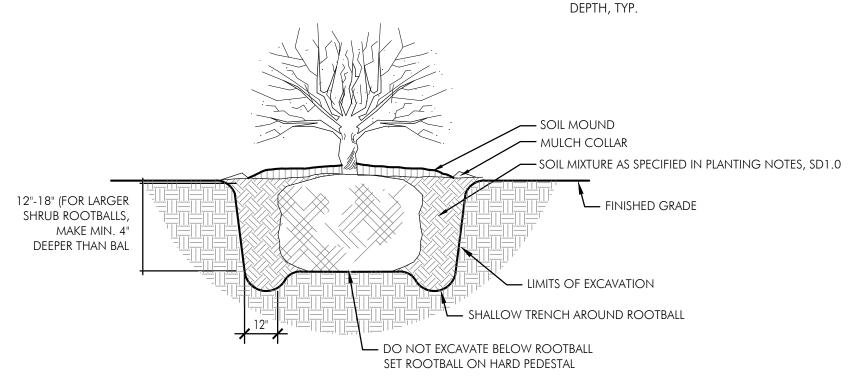

- 3" DEPTH MULCH- SEE NOTES SET ELEVATION AT TOP OF BALL SLIGHTLY HIGHER THAN FINISHED GRADE PLANTING MIXTURE AS SPECIFIED

LOOSEN CIRCLING ROOTS AND SPREAD

SCARIFY 4" DEEP AND RECOMPACT


GIRDLING


THEM OUT BEFORE PLANTING TO AVOID

Perennial Planting
N.T.S.


Shrub Planting N.T.S.

SPACING	Α	В	С	D	A=	SPACING
12"	12"	6"	10"	12"	B=	SP/2
18"	18"	8"	15"	18"	C= D=	SP/1.2 SPACING
24"	24"	10"	20"	24"		31 ACII1O
36"	36"	18"	31"	36"		
48"	48"	21"	41"	48"		

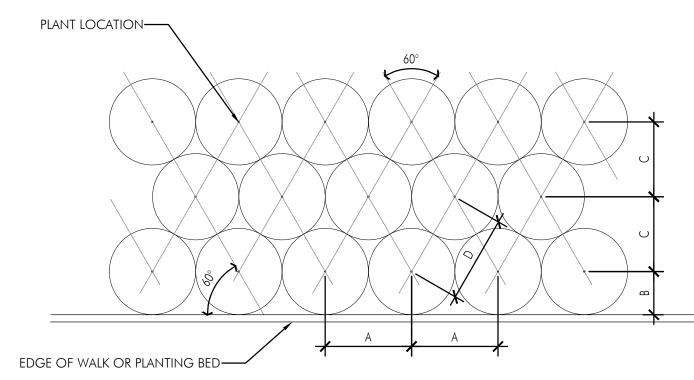

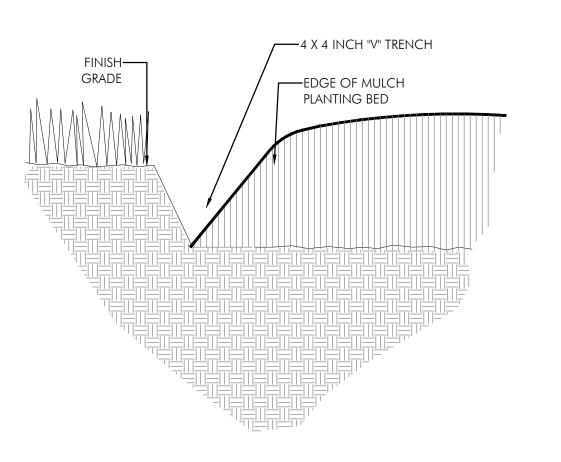


Mulch Edge Treatment at Lawn
N.T.S.

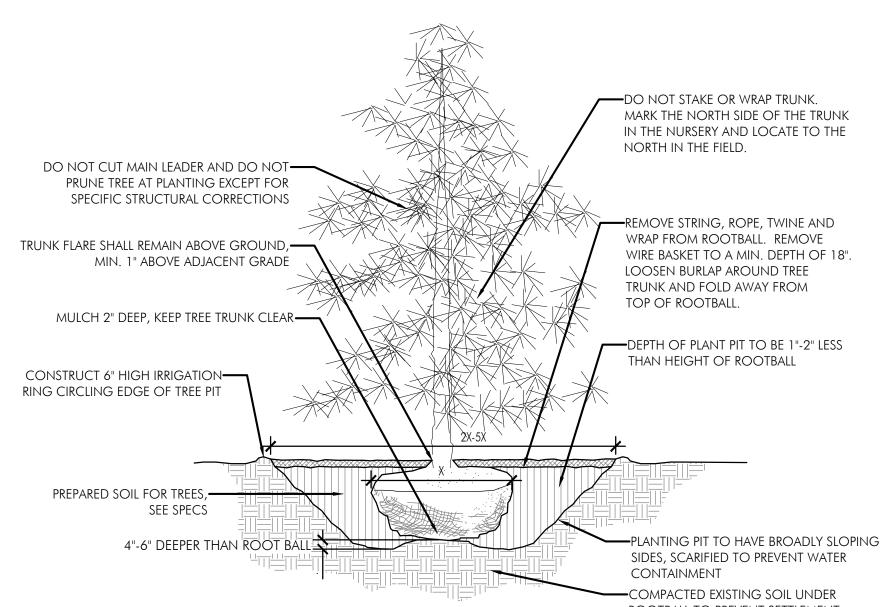

ROOTBALL TO PREVENT SETTLEMENT Evergreen Tree Planting

NOTES: 1. TREES ARE NOT TO BE STAKED UNLESS THEY BECOME UNPLUMBED AT WHICH TIME THEY MAY BE REPLANTED ONCE AND STAKED. 2. MEASURE ROOTBALL AND SET 1" HIGHER ON HARD PEDESTAL, DO NOT DISTURB AREA UNDERNEATH ROOTBALL Staking is as required DO NOT CUT CENTRAL LEADER —— NO MORE THAN 40% CLEAR TRUNK—— —FLARE OF TRUNK VISIBLE ABOVE SOIL LINE UNLESS OTHERWISE SPECIFIED TOP OF ROOT BALL KEPT FREE OF ALL HIGHER THAN FINISHED GRADE BUT A 1" LAYER OF MULCH. DO NOT PILE MULCH OR SOIL AGAINST TRUNK —REMOVE 50% OF WIRE CAGE AND BURLAP ALONG WITH ALL TWINE AND TRUNK WRAP MULCH MOUNDED TO COVER SIDES— OF ROOT BALL FINISHED GRADE DEPTH VARIES, BASED ON SIZE OF ROOTBALL -LIMITS OF EXCAVATION -SHALLOW TRENCH AROUND ROOTBALL -DO NOT EXCAVATE BELOW

Tree Planting

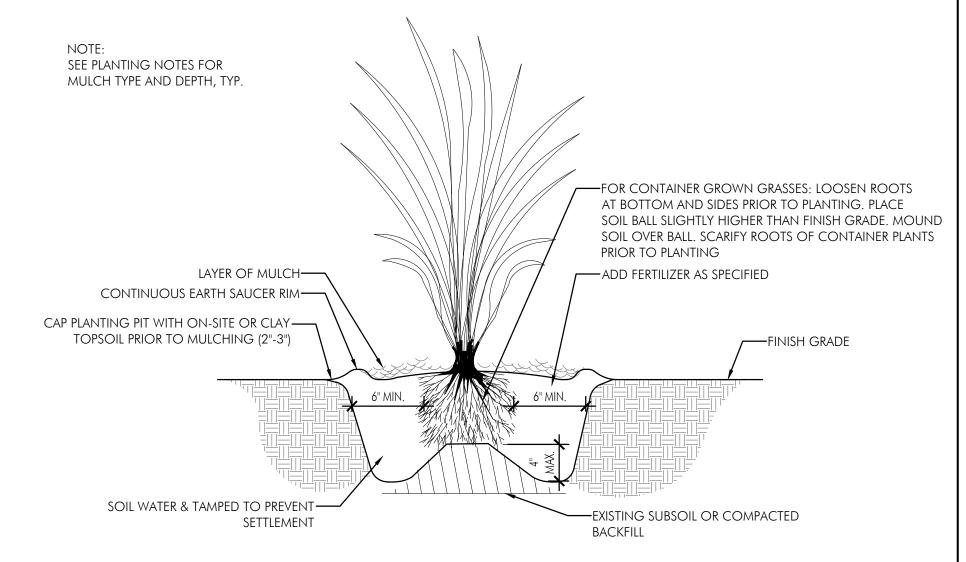

Grass Planting

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Bexley, Ohio

ROOTBALL ON HARD PEDESTAL

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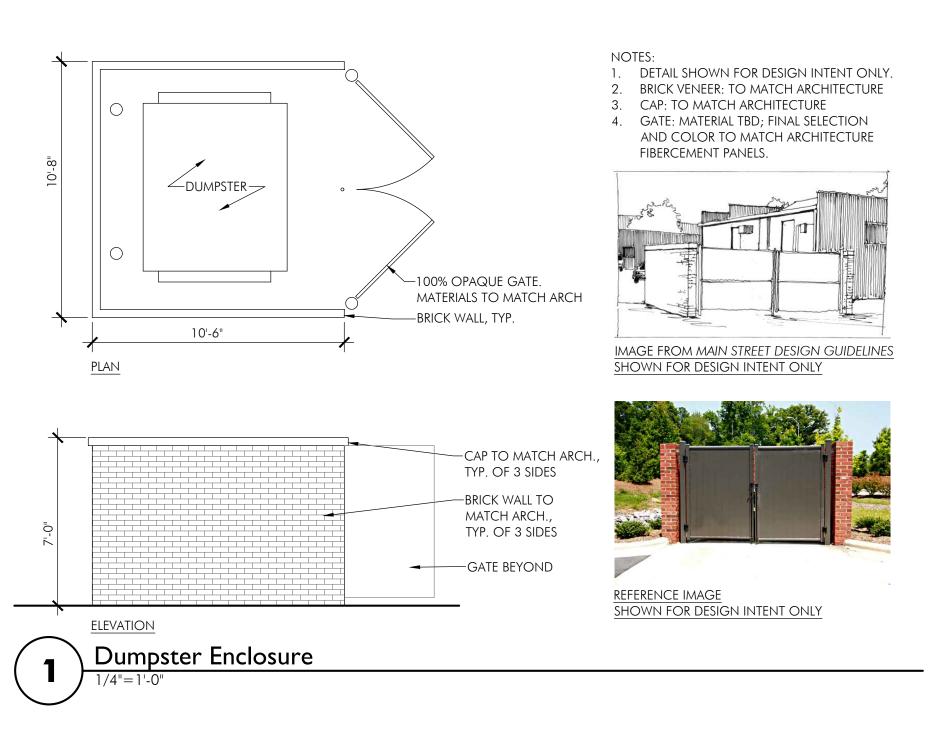
20086 Project # 04/19/2023 Date SO, AC, TF As Shown Scale


Revisions

Sheet Title

PLANTING DETAILS

SD1.0



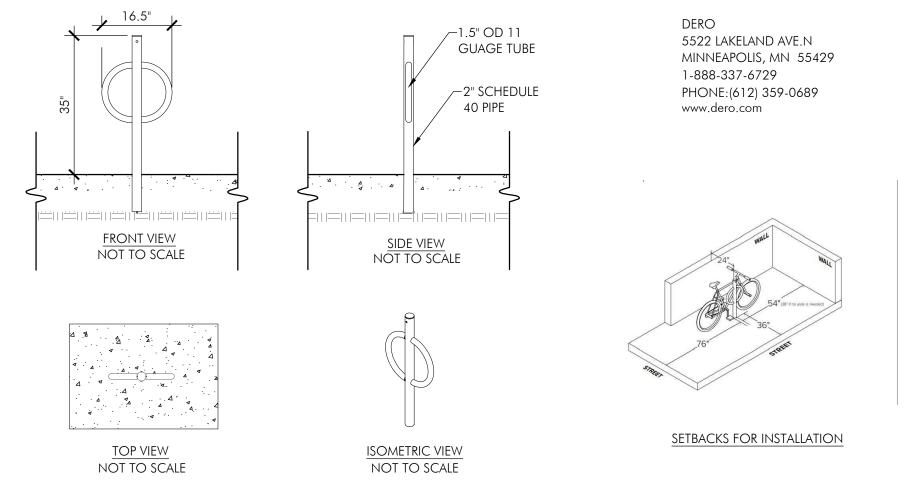

1. INSTALLATION TO BE COMPLETED IN ACCORDANCE WITH MANUFACTURER'S SPECIFICATIONS.

2. DO NOT SCALE DRAWINGS.

3. BIKE RACKS TO BE EMBEDDED IN CONCRETE FOOTINGS, DO NOT SURFACE MOUNT 4. COLOR: POWDER COATED BLACK OR AS SELECTED BY ARCHITECT FROM MANUFACTURER STANDARD COLORS.

Dero Bike Hitch



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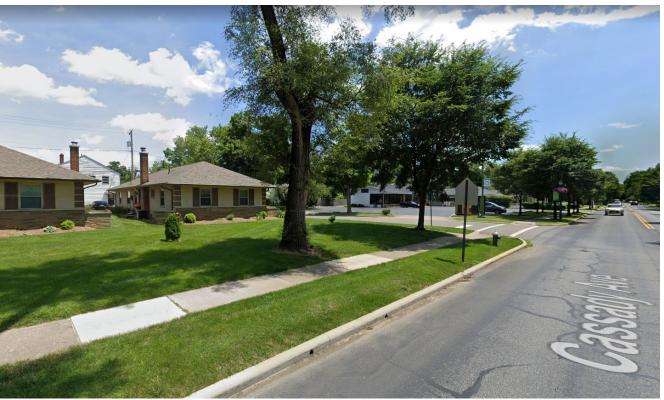
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Sheet Title DETAILS

Sheet #

SD1.1









420 N. CASSADY | STREET VIEWS



3 WEST FLEVATION (NORTH CASSADY AVENUE)



NORTH ELEVATION - COLUMBUS AVENUE

420 N. CASSADY | PROPOSED WEST & NORTH ELEVATIONS



420 N. CASSADY | PROPOSED WEST & NORTH ELEVATIONS



EAST ELEVATION - FACING ALLEY



SOUTH ELEVATION

420 N. CASSADY | PROPOSED SOUTH AND EAST ELEVATIONS



420 N. CASSADY | PROPOSED SOUTH AND EAST ELEVATIONS