

27 parking spaces provided

**Columbus** 

BROOM FINISH CONCRETE PAVING

PROPOSED DECIDUOUS TREE

PROPOSED COLUMNAR TREE

PROPOSED ORNAMENTAL TREE

DECIDUOUS SHRUB

EVERGREEN SHRUB

GROUNDCOVER

LAWN

in well- designed border plantings that frame the lot or within landscape

dd. Dumpsters shall be located behind the principal building and be

screened from public view on all 4 sides, to the height of the dumpster.

beds large enough to sustain successful plant growth.

PERENNIALS, GRASSES, AND

100 Northwoods Blvd, Ste A Columbus, Ohio 43235 p 614.255.3399

Cincinnati

20 Village Square, Floor 3 Cincinnati, Ohio 45246 p 614.360.3066

PODdesign.net

**Project Name Bexley Family** Housing

2300 East Livingston Ave. Bexley, Ohio

7 shade trees required 8 shade trees provided

5 shade trees required

5 shade trees provided

**Prepared For** 

The Community Builders 736 Oak Street Columbus, Ohio 43205



Project Info

24### Project # 11/25/2024 GM, AC Scale As Shown

Revisions

**Sheet Title** CONCEPTUAL **LANDSCAPE PLAN** 

Sheet #

NOTE: LANDSCAPE PLANS SHOWN FOR REFERENCE ONLY. FINAL APPROVAL OF THESE PLANS TO BE OBTAINED BY TREE AND PUBLIC GARDENS COMMISSION



Fence Reference Imagery

II. Minumum parking ratios:

Housing 1.0 per unit: 27 x 1 space =

27 parking spaces required

Evergreen Shrubs Deciduous Shade Trees Ornamental Trees











Regal Prince Oak











## Deciduous Shrubs

Skyline Honeylocust







Hydrangea queecifolia Snow Queen Oakleaf Hydrangea



Fothergilla gardenii Dwarf Fothergilla



Vanilla Spice Summersweet

# Perennials, Grasses, and Groundcover



Pennisetum alopecuroides Hameln Dwarf Fountain Grass



Karl Foerester Reed Grass



Virginia Creeper




Male fern



Liriope spicata Creeping lilyturf



Purple coneflower

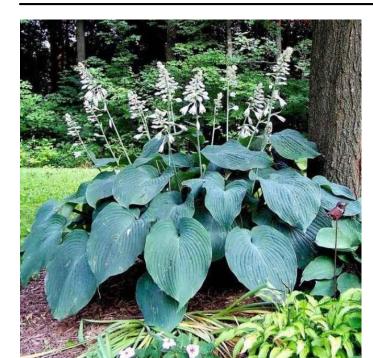

Blue Angel Hosta

Blue Sedge



Schizachyrium scoparium Little bluestem

100 Northwoods Blvd, Ste A Columbus, Ohio 43235 р 614.255.3399

Cincinnati 20 Village Square, Floor 3 Cincinnati, Ohio 45246 р 614.360.3066

**POD**design.net

# **Project Name Bexley Family** Housing

2300 East Livingston Ave. Bexley, Ohio

**Prepared For** 

The Community Builders 736 Oak Street Columbus, Ohio 43205



### Project Info

24### 11/25/2024 GM, AC As Shown

Revisions

**Sheet Title PLANT PALETTE IMAGERY** 


Sheet #






#### 2300 E Livingston: Vicinity Map




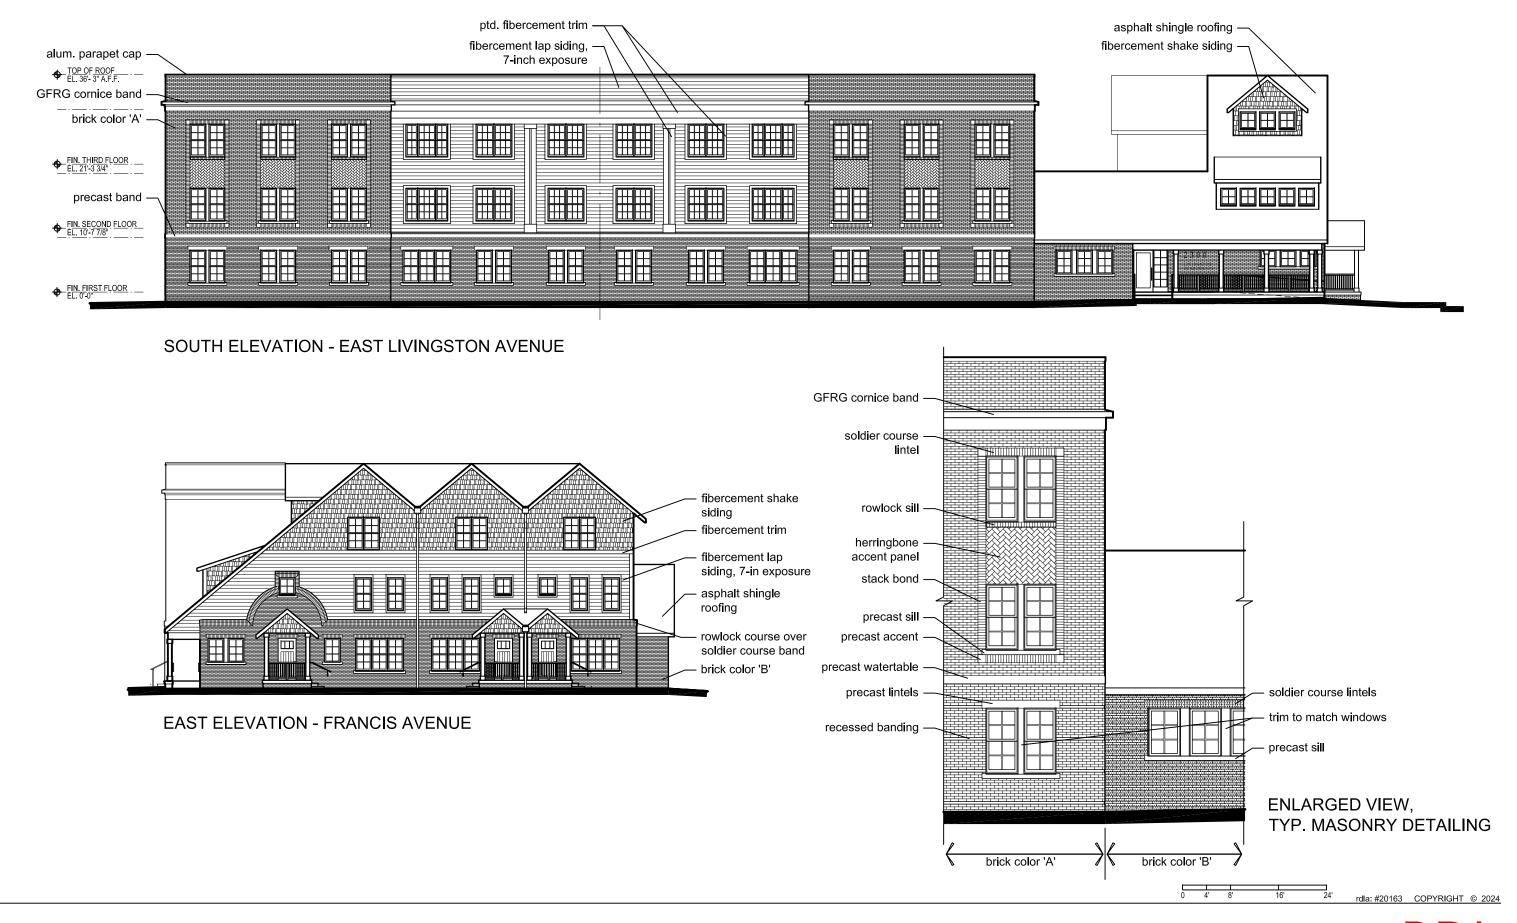

**ARCHITECTS** 

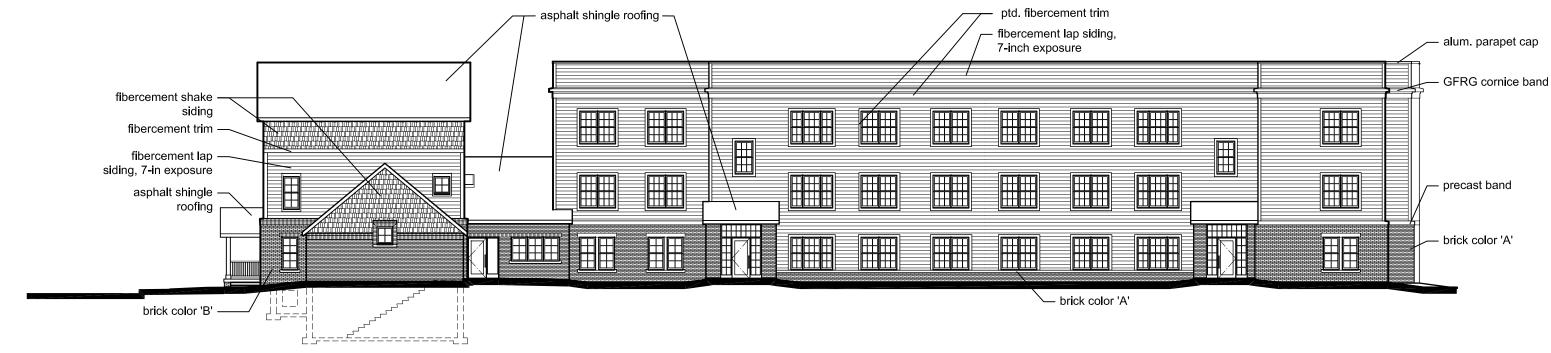



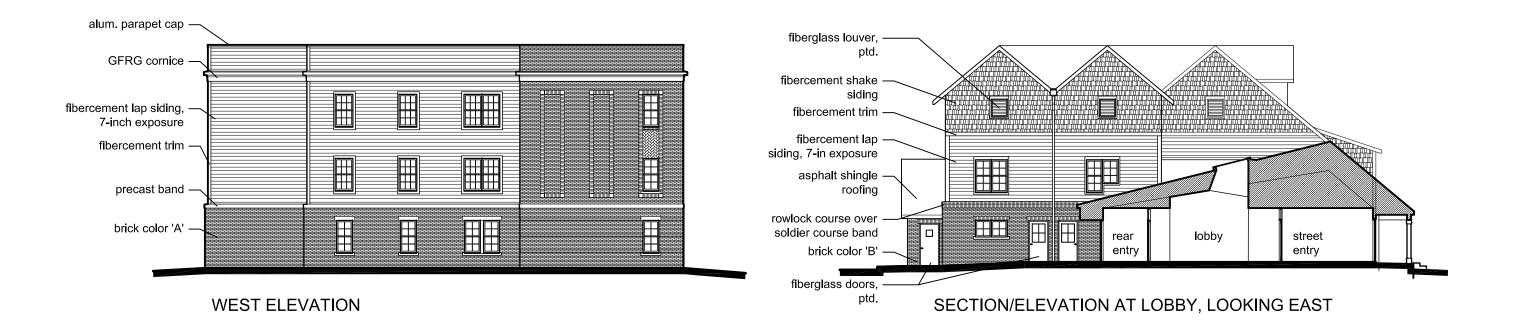







SOUTH ELEVATION - EAST LIVINGSTON AVENUE



**EAST ELEVATION - FRANCIS AVENUE** 

December 9, 2024 RDLA# 20163P COPYRIGHT © 2024












**WEST ELEVATION** 



SECTION/ELEVATION AT LOBBY, LOOKING EAST


December 9, 2024 RDLA# 20163P COPYRIGHT © 2024



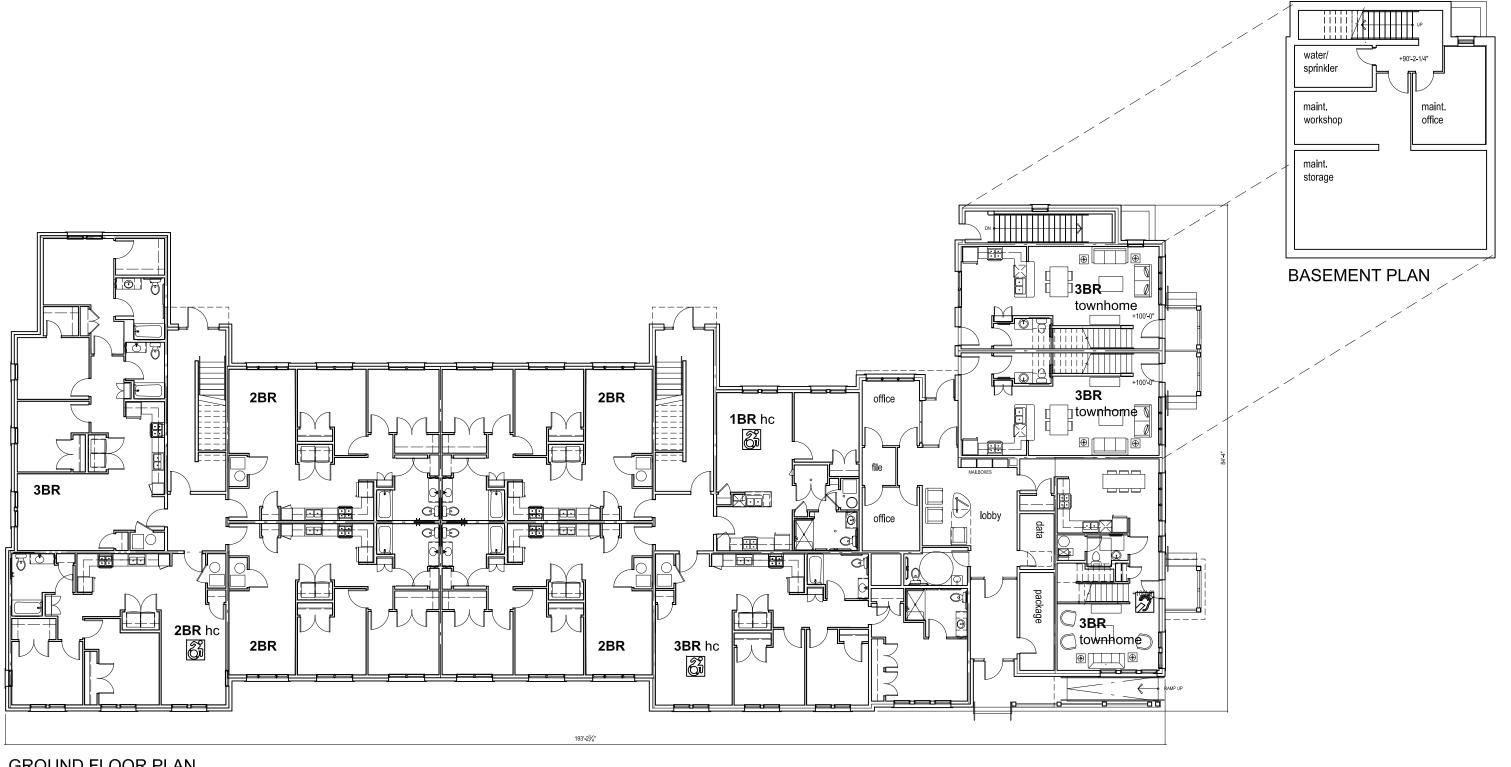


**GROUND FLOOR PLAN** 12,311 GSF FOOTPRINT



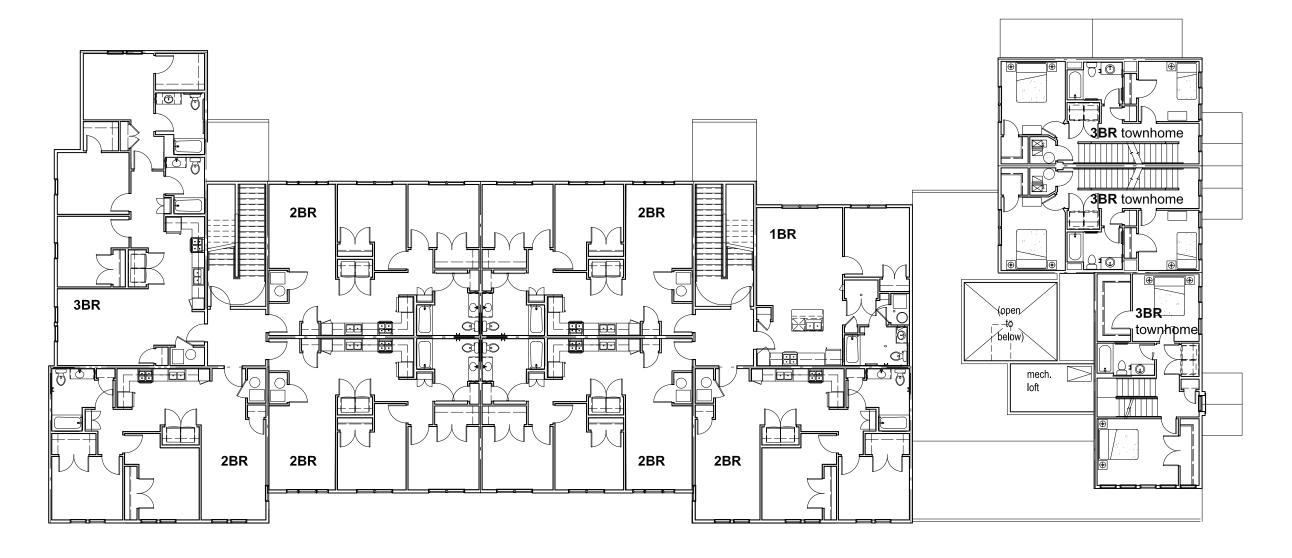


SECOND FLOOR PLAN

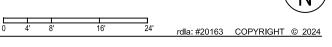





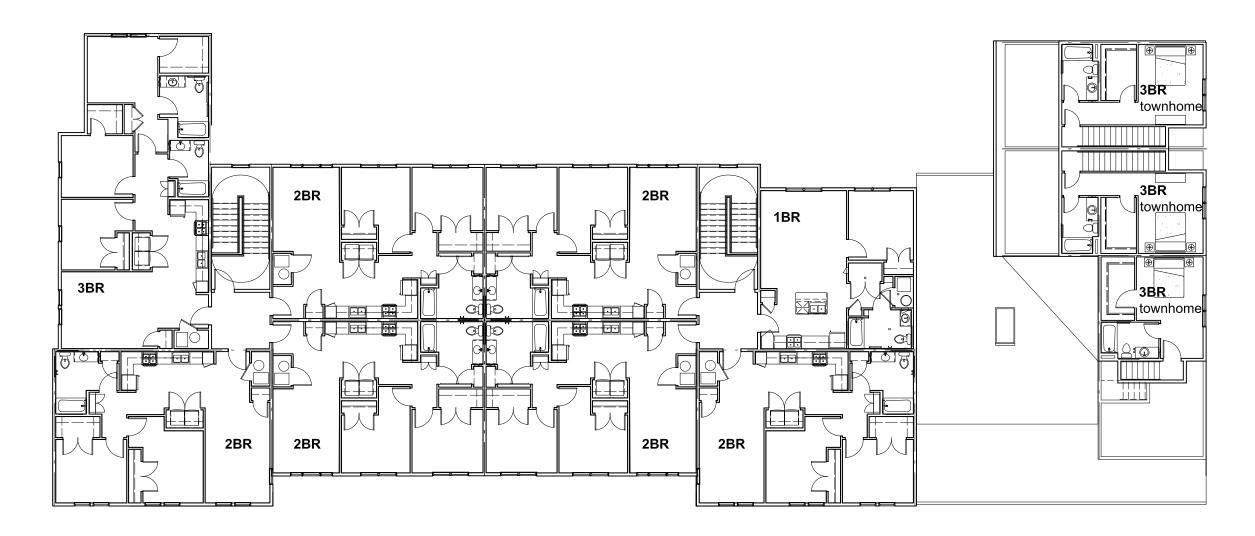

THIRD FLOOR PLAN







Enlarged South Elevation 'Apartment' portion



Enlarged East Elevation 'Townhome' portion




ALUMINUM STOREFRONTS

KAWNEER PERMAFLUOR ARCHITECTURAL COATING COLOR: "ANTIQUE BRONZE"



### FIBER CEMENT SHAKE SIDING

JAMES HARDIE OR SIMILAR FIBER CEMENT SHAKE SIDING FIELD PAINTED SHERWIN WILLIAMS PAINT "ALABASTER" SW 7008

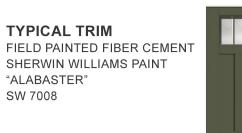

### TOWNHOME ENTRY DOORS

THERMATRU FIBERGLASS CRAFTSMAN DOOR SHERWIN WILLIAMS PAINT "ROCKWOOD GREEN" SW 2816




### TYPICAL FIBER CEMENT LAP SIDING

JAMES HARDIE FIBER CEMENT SMOOTH LAP SIDING COLOR: "ROYCROFT VELLUM" SW 2833 AND "BUTTER UP" SW 6681



#### **TYPICAL WINDOW**

PELLA 250 SERIES
HIGH PERFORMANCE
WINDOWS OR SIMILAR.
COLOR "FOSSIL" SINGLE
HUNG CONFIGURATION

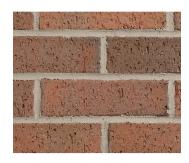

#### **BRICK COLOR A**

GLEN-GERY
EXTRUDED FACE BRICK,
CITY LINE SERIES. BLADE CUT
"AUTUMN HARVEST BLEND"



#### BRICK COLOR B

GLEN-GERY
EXTRUDED FACE BRICK,
URBAN GRAY VELOUR SERIES.
"BEIGE GRAY VELOUR"



# PRECAST ARCHITECTURAL CONCRETE WATERTABLE COURSE


ROCK CAST ARCHITECTURAL CAST STONE SMOOTH FINISH "RIESLING"




#### **ROOF SHINGLES**

CERTAINTEED LANDMARK SERIES "WEATHERED WOOD"

12.12.2024 RDL 20163P

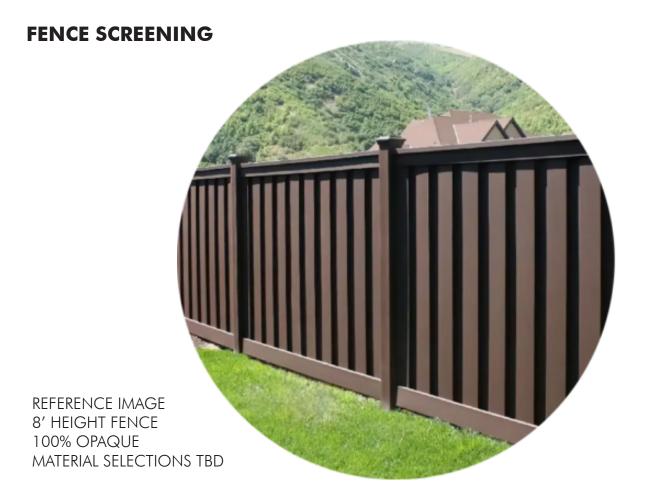

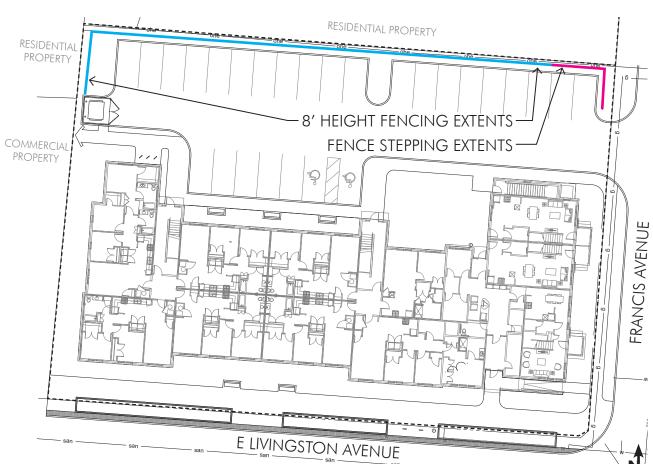



**ELEVATION** 



PERSPECTIVE