

SECOND FLOOR DEMO PLAN
A2 SCALE: 1/4"-1'-0"

Shawn McAllister SHAWN T. MCALLISTER DEMO PLAN JOB # 410123 SHEET NUMBER

205 S. Cassingham Road
Revley, OH

DETECTOR NOTES

S SMOKE DETECTOR

314.1 Smoke detection and notification. All smoke alarms shall be listed in accordance with UL 217 and installed in accordance with the provisions of this code and the household fire warning equipment provisions of NFPA 72.

314.2 Smoke detection systems. Household fire alarm systems installed in accordance with NFPA 72 that include smoke alarms, or a combination of smoke detector and audible notification device installed as required by this section for smoke alarms, shall be permitted. The household fire alarm system shall provide the same level of smoke detection and alarm as required by this section for smoke alarms. Where a household fire warning system is installed using a combination of smoke detector and audible notification device(s), it shall become a permanent fixture of the occupancy and owned by the homeowner. The system shall be maintained in accordance with NFPA 72.

314.3 Location. Smoke alarms shall be installed in the following locations: I. In each sleeping room.

2. Outside each separate sleeping area in the immediate vicinity of the

3. On each additional story of the dwelling, including basements and habitable attics but not including crawl spaces and uninhabitable attics. In dwellings or dwelling units with split levels and without an intervening door between the adjacent levels, a smoke alarm installed on the upper level shall suffice for the adjacent lower level provided that the lower level is less than one full story below the upper level. When more than one smoke alarm is required to be installed within an individual

dwelling unit the alarm devices shall be interconnected in such a manner that the actuation of one alarm will activate all of the alarms in the individual unit. 314.4 Power source. Smoke alarms shall receive their primary power from the

primary power is interrupted, shall receive power from a battery. Wiring shall be permanent and without a disconnecting switch other than those required for overcurrent protection. Smoke alarms shall be interconnected.

I. Smoke alarms shall be permitted to be battery operated when installed in buildings without commercial power.


2. Interconnection and hard-wiring of smoke alarms in existing areas shall not be required where the alterations or repairs do not result in the removal of interior wall or ceiling finishes exposing the structure, unless there is an attic, crawl space or basement available which could provide access for hard wiring and interconnection without the removal of interior finishes.

CARBON MONOXIDE ALARM

315.1 Carbon monoxide alarms. For new construction, an approved carbon monoxide alarm shall be installed outside of each separate sleeping area in the immediate vicinity of the bedrooms in dwelling units within which fuel-fired appliances are installed and in dwelling units that have attached garages.

315.2 Where required. Where work requiring a permit occurs in existing dwellings that have attached garages or in existing dwellings within which fuelfired appliances exist, carbon monoxide alarms shall be provided in accordance with Section 315.1.

315.3 Alarm requirements. Single station carbon monoxide alarms shall be listed as complying with UL 2034 and shall be installed in accordance with this code and the manufacturer's installation instructions.

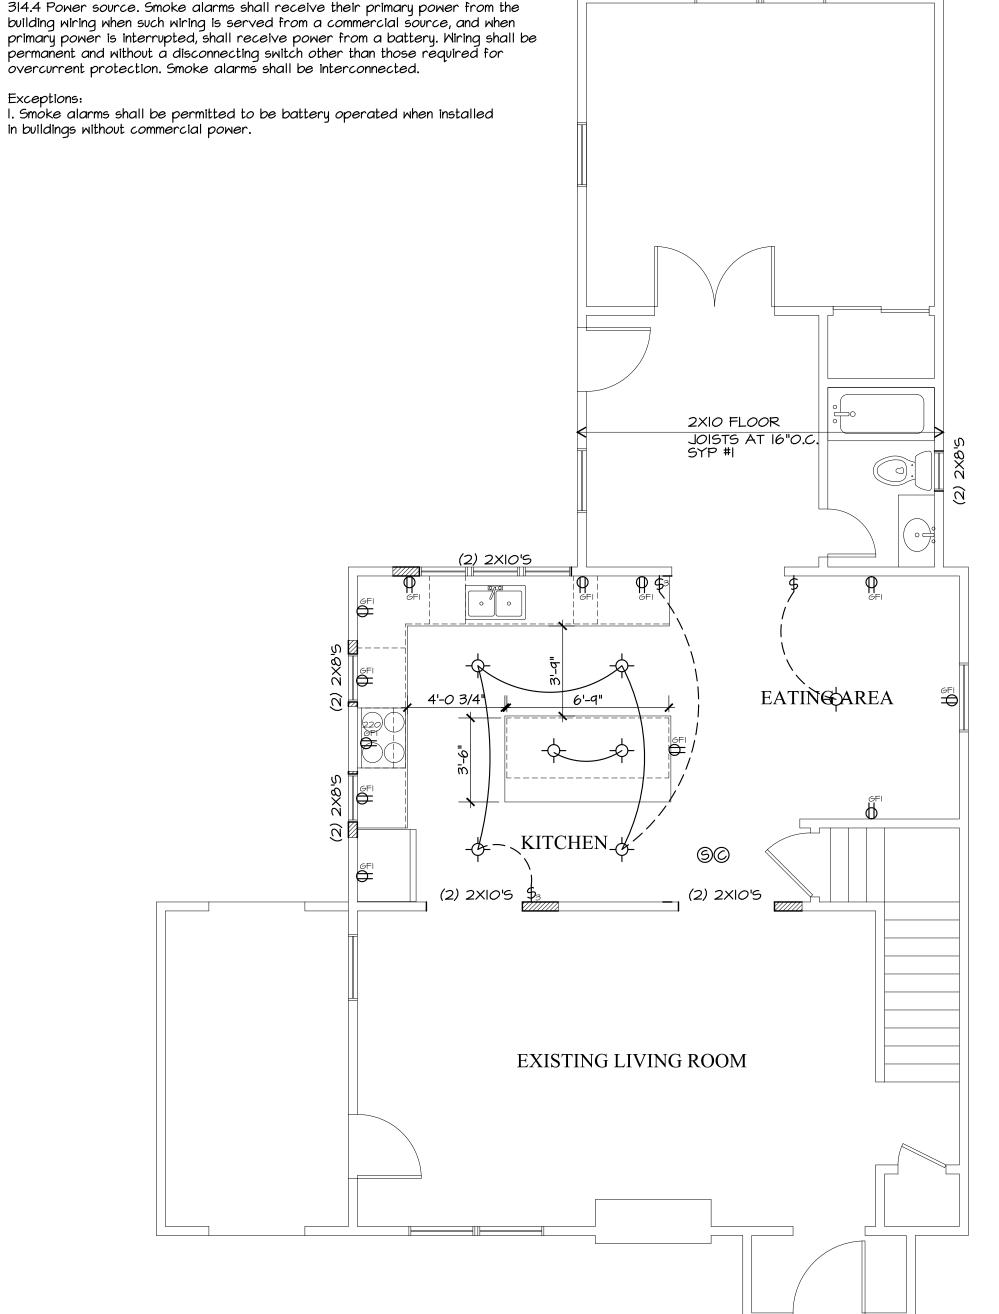

FIRST FLOOR PLAN A2 SCALE: 1/4"-1'-0" PRESCRIPTIVE INSULATION SCHEDULE

	FENESTRATION U-FACTOR	SKYLIGHT	GLAZED FENESTRATION SHGC		MOOD FRAME WALL R-VALUE	MASS WALL R-VALUE	FL <i>OO</i> R R-VALUE	BASEMENT WALL R-VALUE	SLAB R-VALUE AND DEPTH	CRAWL SPACE WALL R-VALUE
5	0.30	0.55	NR	49	R20 OR RI3 PLUS R5 INS. SHEATHING	13/17	30	IO CONT. OR I3 CAVITY	IO, 2 FT.	IO CONT. OR I3 CAVITY

HERE ALIGN WITH BELOW MASTER. **MASTER** ALIGN WITH BELOW (2) 2X8'S EXISTING BEDROOM **EXISTING** BATH **EXISTING EXISTING BEDROOM BEDROOM**

DINING

MINDOM

RELOCATED

SHEATHING PER ORC

WALL BRACING 7/16" EXTERIOR GRADE OSB SHEATHING - CONTINUOUS STRUCTURAL PANEL

PROVIDE I JACK STUD AND I KING STUD FOR 3' OPENING OR LESS, UNLESS NOTED OTHERWISE PROVIDE 2 JACK STUDS AND I KING STUD FOR 4' TO 6' OPENING, UNLESS NOTED OTHERWISE PROVIDE 3 JACK STUDS AND I KING STUD FOR 6' OPENING AND ABOVE, UNLESS NOTED OTHERWISE

SECOND FLOOR PLAN

A2 SCALE: 1/4"-1'-0"

M assingham **O** X 0 M 0

S


Allister


Shawn


SHAWN

MCALLISTER

SCALE: JOB # 410123 SHEET NUMBER

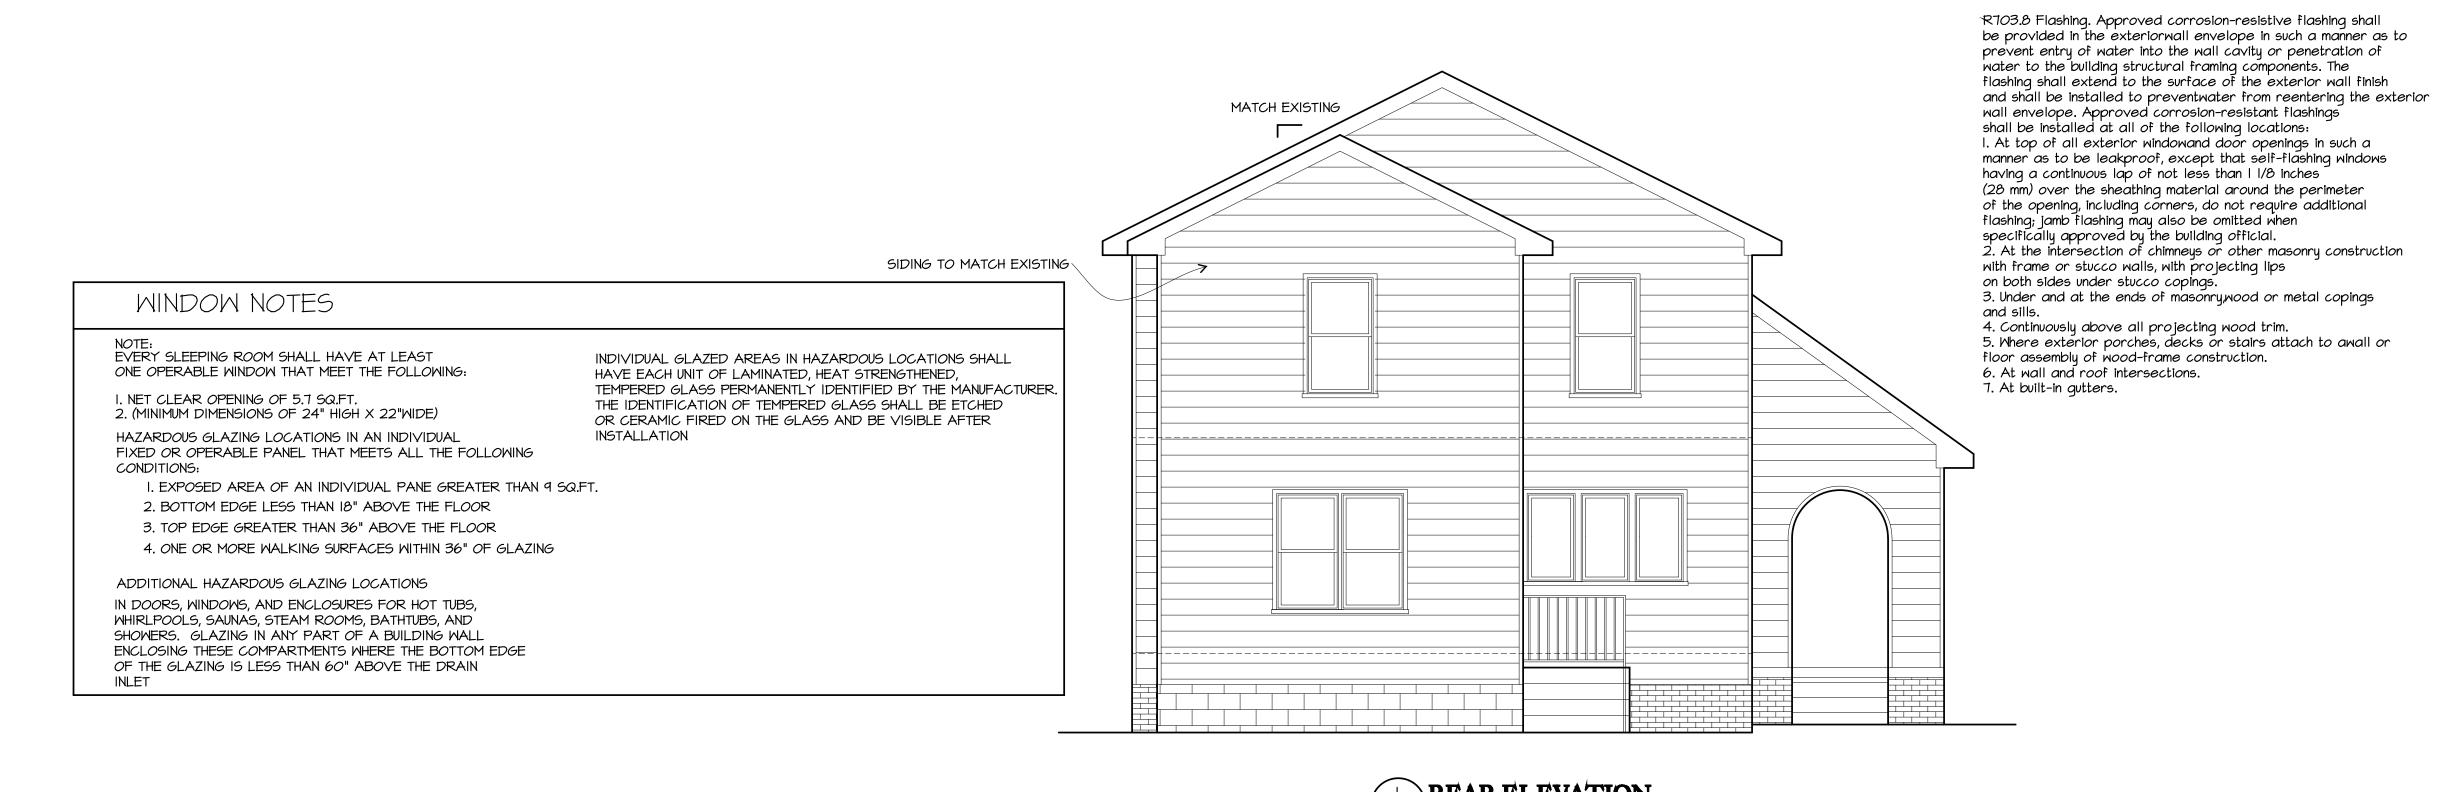

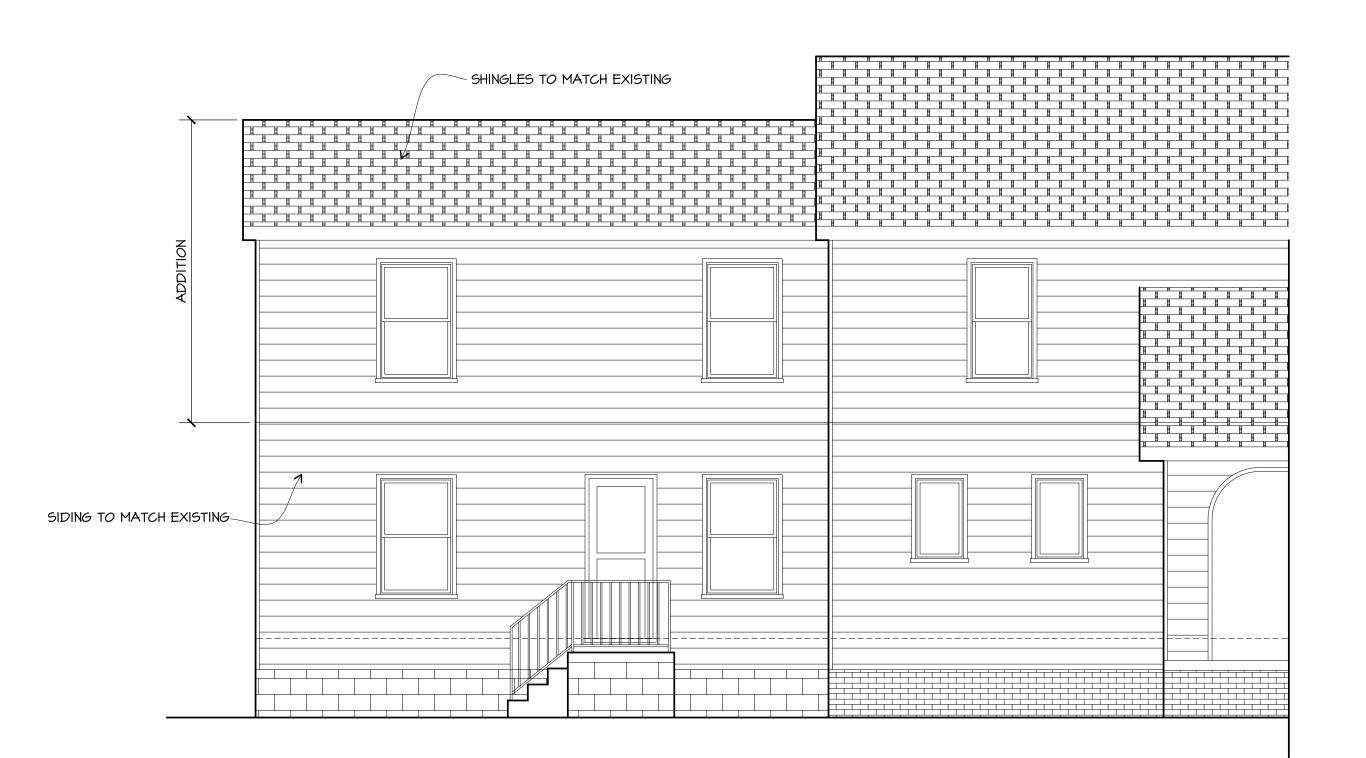

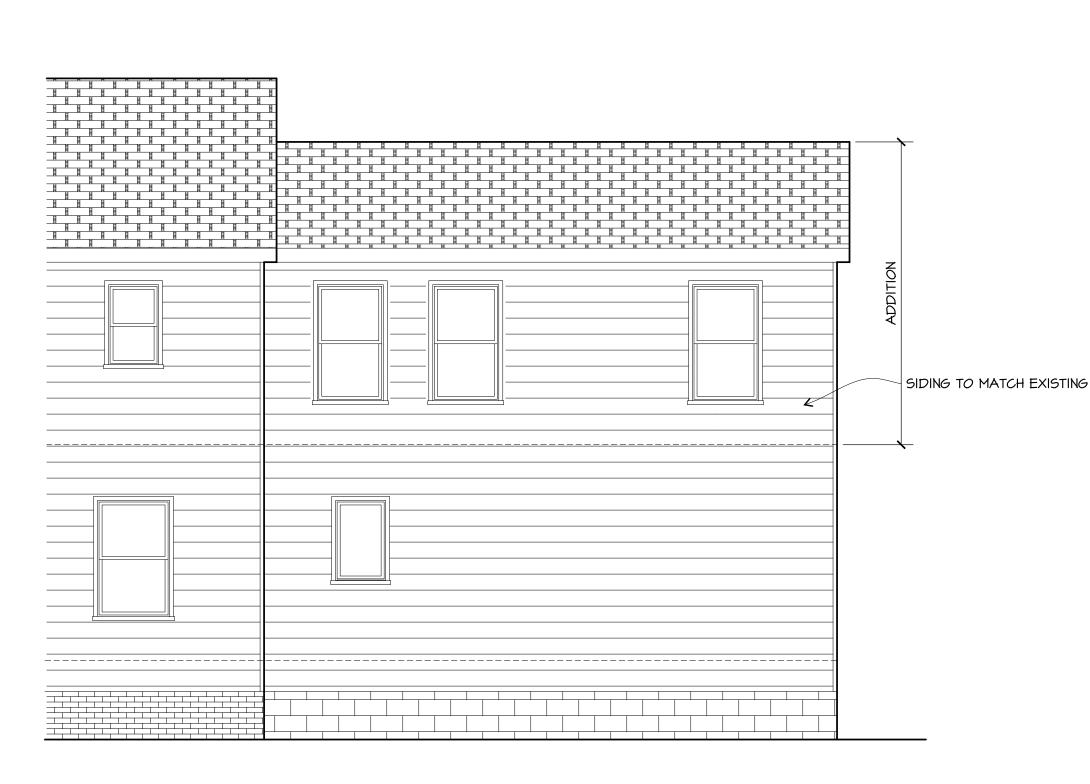

SIDE ELEVATION
A2 SCALE: 1/4%-1'-0%

S. Cassingham Roac Bexley, OH

5

0

2

FLASHING NOTES:

130 N. Maple Street Marysville, OH 43040

TE OF O SHAWN
T.

MCALLISTER

12139

REVISIONS

ELEVATIONS

ALE: 1/4"=1'-0"

EXTERIOR ELEVATIO:
JOB # 410123 | SCALE: 1/4"=1'-0"

SHEET NUMBER

A2

VENTILATION CALCULATIONS

RIDGE VENTS PROVIDE 16 SQ. IN. PER LIN. FT. 672/300 = 2.24 SQ.FT. OF VENT REQD. FREE AIR SPACE VENTILATION

3.3 SQ.FT. PROVIDED

X

assingham


0

xle

0

M

VENTED SOFFIT MATERIAL PROVIDES 8.2 SQ. IN. PER LIN. FT. FREE AIR SPACE VENTILATION

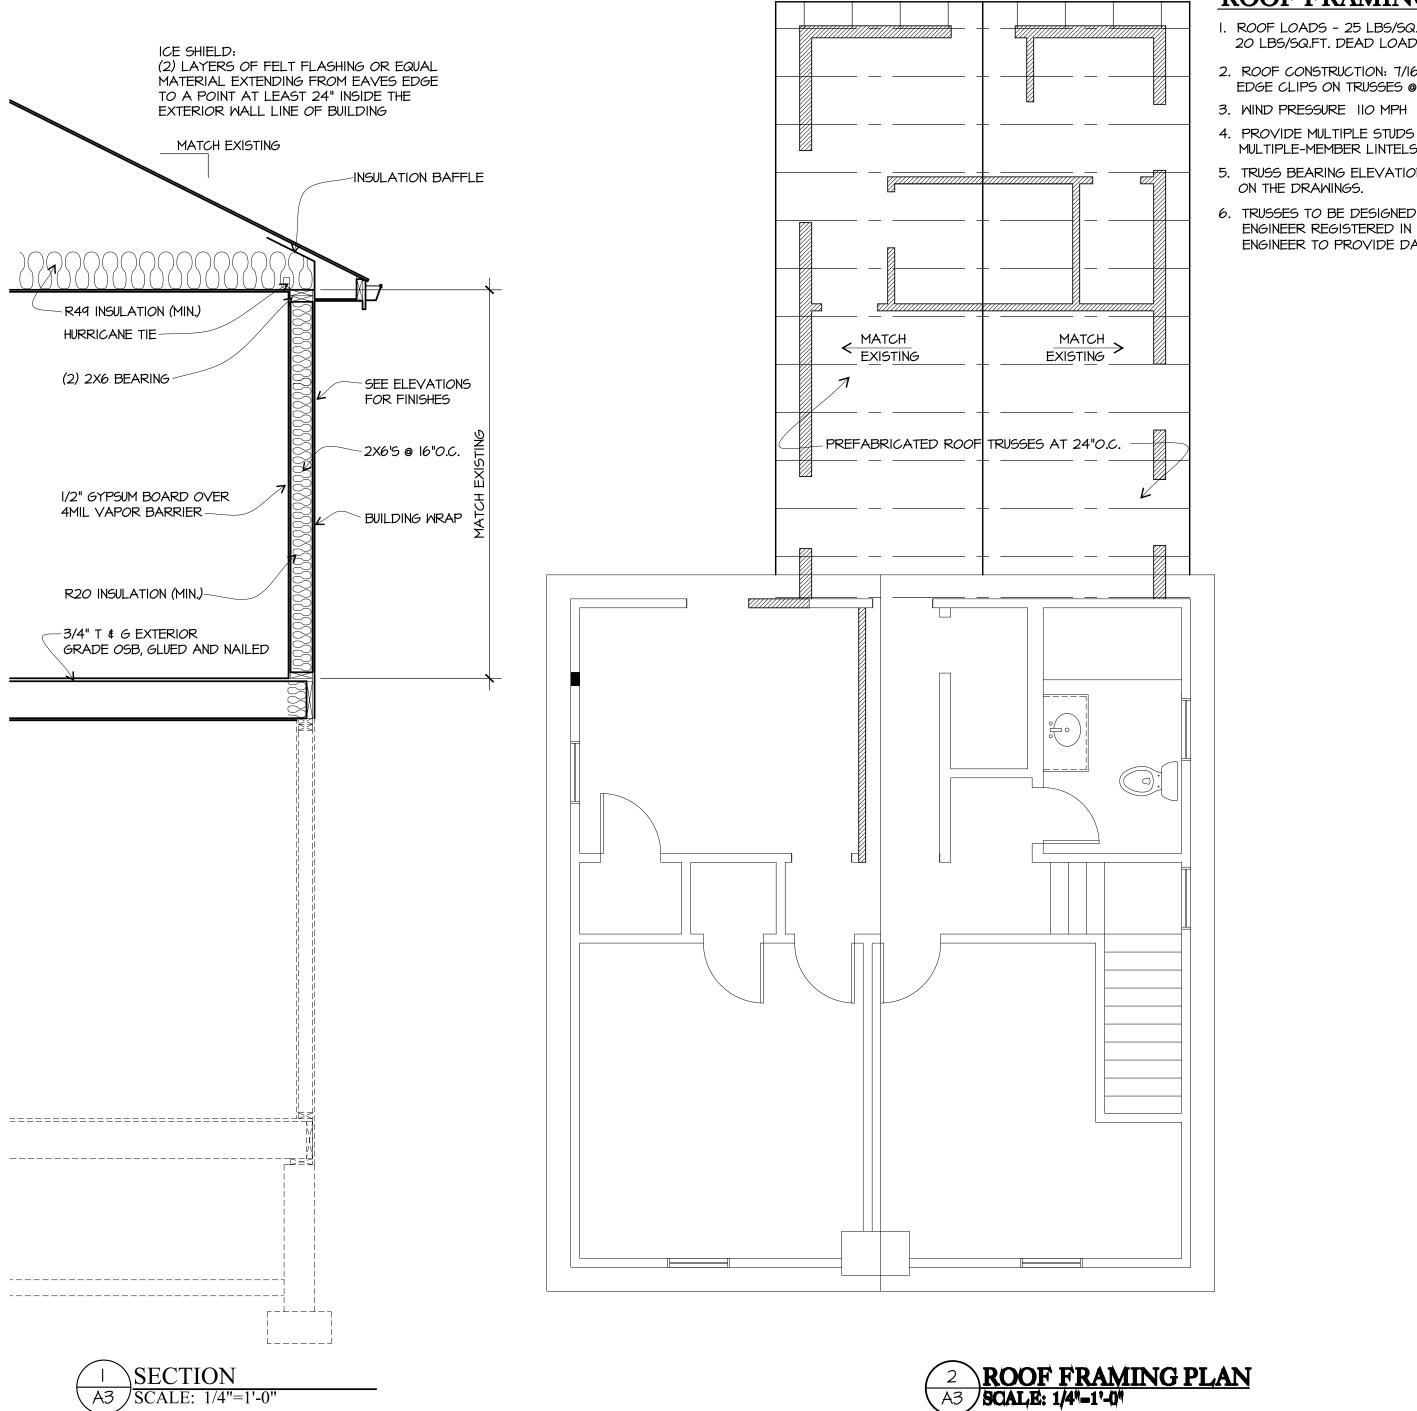

ROOF FRAMING NOTES

- I. ROOF LOADS 25 LBS/SQ.FT. LIVE LOAD AND 20 LBS/SQ.FT. DEAD LOAD
- 2. ROOF CONSTRUCTION: 7/16" OSB SHEATHING WITH EDGE CLIPS ON TRUSSES @ 24"O.C.
- 4. PROVIDE MULTIPLE STUDS DIRECTLY BELOW MULTIPLE-MEMBER LINTELS.
- TRUSS BEARING ELEVATIONS INDICATED ON THE DRAWINGS.
- 6. TRUSSES TO BE DESIGNED BY A STRUCTURAL

ENGINEER REGISTERED IN THE STATE OF OHIO. ENGINEER TO PROVIDE DATA AND LAYOUT.

Shawn

SHEET NUMBER